

LOCUS MAP SCALE: 1" = 250'

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## ZONING DISTRICT LIMITED INDUSTRY (LI)

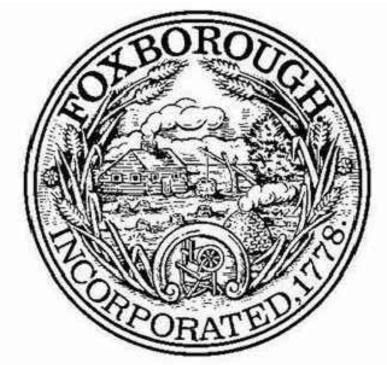
Required DIMENSION Proposed Min. Lot Frontage (ft.) 50 832.3 88.66 - Building Min. Front Yard (ft.) 50 42.5 - Fuel Canopy\* 36.9-Ex. Admin Buildin Min. Side Yard (ft.) 25 10.1- Exist Shed\* 77.3 - DPW Building 50 Min. Rear Yard (ft.) 42.0 - Exist Storage Building\* 70 73.8\*\* Maximum Lot Coverage (% 34 906.8 Min. Lot Width (ft.) 31.6 Building Height (ft.) 40

\*Existing Non-Conforming to remain

\*\* Variance Required

# TOWN OF FOXBOROUGH, MASSACHUSETTS

## **PUBLIC WORKS FACILITY ADDITION AND RENOVATION**



## SITE PLAN REVIEW

## 70 ELM STREET, FOXBOROUGH, MA MAP 107, PARCEL 107-036-000

**APPLICANT:** 

TOWN OF FOXBOROUGH 70 ELM STREET FOXBOROUGH, MA 02035

CONTACT CHRISTOPHER GALLAGHER, DPW DIRECTOR CGALLAGHER@ FOXBOROUGHMA.GOV (781)389-6139







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File No ENG22-0799

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## **DEMOLITION & SITE PREPARATION NOTES**

- THE CONTRACTOR SHALL INCLUDE IN THE BID THE COST OF REMOVING ANY EXISTING SITE FEATURES AND APPURTENANCES 1. ALL WORK RELATING TO INSTALLATION, RENOVATION OR MODIFICATION OF WATER, DRAINAGE AND/OR SEWER SERVICES NECESSARY TO ACCOMPLISH THE CONSTRUCTION OF THE PROPOSED SITE IMPROVEMENTS. THE CONTRACTOR SHALL ALSO INCLUDE IN THE BID THE COST NECESSARY TO RESTORE SUCH ITEMS IF THEY ARE SCHEDULED TO REMAIN AS PART OF THE FINAL SITE IMPROVEMENTS. REFER TO PLANS TO DETERMINE EXCAVATION, DEMOLITION AND TO DETERMINE THE LOCATION OF THE PROPOSED SITE IMPROVEMENTS.
- THE OWNER RESERVES THE RIGHT TO REVIEW ALL MATERIALS DESIGNATED FOR REMOVAL AND TO RETAIN OWNERSHIP OF SUCH MATERIALS. IF THE OWNER RETAINS ANY MATERIAL THE CONTRACTOR SHALL MAKE ARRANGEMENTS WITH THE OWNER TO HAVE THOSE MATERIALS REMOVED OFF SITE AT NO ADDITIONAL COST.
- 3. UNLESS SPECIFICALLY NOTED TO BE SAVED / STOCKPILED (R&S) OR REUSED / RELOCATED (R&R), ALL SITE FEATURES CALLED FOR REMOVAL (REM) SHALL BE REMOVED WITH THEIR FOOTINGS, ATTACHMENTS, BASE MATERIAL, ETC, TRANSPORTED FROM THE SITE TO BE DISPOSED OF IN A LAWFUL MANNER AT AN ACCEPTABLE DISPOSAL SITE AND AT NO COST TO THE OWNER.
- 4. ALL EXISTING SITE FEATURES TO REMAIN SHALL BE PROTECTED THROUGHOUT THE CONSTRUCTION PERIOD. ANY FEATURES DAMAGED DURING CONSTRUCTION OPERATIONS SHALL BE REPAIRED OR REPLACED TO THE SATISFACTION OF THE OWNER'S REPRESENTATIVE AT NO ADDITIONAL COST.
- 5. DURING EARTHWORK OPERATIONS, CONTRACTOR SHALL TAKE CARE TO NOT DISTURB EXISTING MATERIALS TO REMAIN, OUTSIDE THE LIMITS OF EXCAVATION AND BACKFILL AND SHALL TAKE WHATEVER MEASURES NECESSARY, AT THE CONTRACTOR'S EXPENSE, TO PREVENT ANY EXCAVATED MATERIAL FROM COLLAPSING. ALL BACKFILL MATERIALS SHALL BE PLACED AND COMPACTED AS SPECIFIED TO THE SUBGRADE REQUIRED FOR THE INSTALLATION OF THE REMAINDER OF THE CONTRACT WORK.
- 6. IT SHALL BE THE CONTRACTOR'S OPTION, WITH CONCURRENCE OF THE OWNER, TO REUSE EXISTING GRAVEL IF IT MEETS THE REQUIREMENTS OF THE SPECIFICATIONS FOR GRAVEL BORROW.
- 7. ALL ITEMS CALLED FOR REMOVAL SHALL BE REMOVED TO FULL DEPTH INCLUDING ALL FOOTINGS, FOUNDATIONS, AND OTHER APPURTENANCES, EXCEPT AS SPECIFICALLY NOTED OTHERWISE. 8. 'CLEAR AND GRUB VEGETATION' SHALL INCLUDE REMOVAL OF GRASS, SHRUBS, AND UNDERBRUSH, REMOVAL OF ROOTS, ROUGH GRADING, INSTALLATION OF LOAM (IF APPLICABLE), FINE GRADING, SEEDING AND TURF ESTABLISHMENT BY THE
- CONTRACTOR. TREES DESIGNATED FOR REMOVAL SHALL BE TAGGED BY CONTRACTOR AND APPROVED BY OWNER'S REPRESENTATIVE
- 10. THE STORAGE OF MATERIALS AND EQUIPMENT WILL BE PERMITTED AT LOCATIONS DESIGNATED BY OWNER OR OWNER'S REPRESENTATIVE. PROTECTION OF STORED MATERIALS AND EQUIPMENT SHALL BE THE SOLE RESPONSIBILITY OF THE
- 11. STRIP & STORE EXISTING TOPSOIL FOR LATER REUSE WHERE APPROPRIATE, AND AS NOTED ON PLAN, WITH APPROPRIATE EROSION AND SEDIMENT CONTROLS.
- 12. THE CONTRACTOR SHALL PROTECT EXISTING TREES TO REMAIN, CONTRACTOR SHALL INSTALL TREE PROTECTION BARRIER AFTER CLEARING UNDERBRUSH AND TAKE DUE CARE TO PREVENT INJURY TO TREES DURING CLEARING OPERATIONS.

## LAYOUT & MATERIALS NOTES

PRIOR TO COMMENCEMENT OF CONSTRUCTION.

CONTRACTOR.

- 1. REFER TO EXISTING CONDITIONS PLANS FOR SURVEY INFORMATION (SHEET C100).
- 2. COORDINATE ALL LAYOUT ACTIVITIES WITH THE SCOPE OF WORK CALLED FOR BY DEMOLITION, GRADING AND UTILITIES OPERATIONS ENCOMPASSED BY THIS CONTRACT. SET, PROTECT AND REPLACE REFERENCE STAKES AS NECESSARY OR AS REQUIRED BY THE OWNER'S REPRESENTATIVE.
- 3. ALL WORK SHALL BE PERFORMED BY CONTRACTOR UNLESS SPECIFICALLY INDICATED THAT THE WORK WILL BE PERFORMED "BY TOWN".
- 4. THE LAYOUT OF SITE AMENITIES AND FENCES MUST BE APPROVED BY THE OWNER'S REPRESENTATIVE PRIOR TO INSTALLATION.
- 5. THE LAYOUT OF ALL NEW PATHWAYS / WALKWAYS AND THE GRADING OF ALL SLOPES AND CROSS SLOPES SHALL CONFORM TO THE COMMONWEALTH OF MASSACHUSETTS RULES AND REGULATIONS FOR HANDICAP ACCESS CMR 521, AND THE AMERICANS WITH DISABILITIES ACT (ADA), TITLE 3. THE CONTRACTOR SHALL NOTIFY THE OWNER IMMEDIATELY OF ANY DISCREPANCIES BETWEEN ACTUAL CONDITIONS AND THOSE REQUIRED.
- 6. ALL LAYOUT LINES, OFFSETS, OR REFERENCES TO LOCATING OBJECTS ARE EITHER PARALLEL OR PERPENDICULAR UNLESS OTHERWISE DESIGNATED WITH ANGLE OFFSETS NOTED.
- 7. ALL PROPOSED SITE FEATURES SHALL BE LAID OUT AND STAKED FOR REVIEW AND APPROVAL BY THE OWNER'S REPRESENTATIVE PRIOR TO COMMENCEMENT OF INSTALLATION. ANY REQUIRED ADJUSTMENTS TO THE LAYOUT SHALL BE UNDERTAKEN AS DIRECTED, AT NO ADDITIONAL COST TO THE OWNER.
- 8. ALL PROPOSED PAVEMENTS SHALL MEET THE LINE AND GRADE OF EXISTING ADJACENT PAVEMENT SURFACES AND SHALL BE TREATED WITH AN RS-1 TACK COAT AT POINT OF CONNECTION. ALL PATHWAY WIDTHS SHALL BE AS NOTED ON THE LAYOUT AND MATERIALS PLAN.
- 9. THE CONTRACTOR SHALL VERIFY ALL DIMENSIONS AND GRADES ON THE GROUND AND REPORT ANY DISCREPANCIES IMMEDIATELY TO THE OWNER.
- 10. THE CONTRACTOR SHALL BE RESPONSIBLE FOR FIELD MEASUREMENT OF ALL PROPOSED FENCES AND GATES.
- 11. THE DEPTH OF LOAM BORROW FOR ALL PROPOSED LAWN AREAS SHALL BE 4" MINIMUM. ALL DISTURBED AREAS SHALL BE RESTORED WITH LOAM AND SEED UNLESS OTHERWISE NOTED
- 12. ALL REFERENCES TO LOAM AND SEED (L&S) REFER TO HYDROMULCH SEEDED LAWN. 13. REFER TO DETAIL DRAWINGS FOR CONSTRUCTION DETAILS.
- **EROSION AND SEDIMENT CONTROL NOTES** ALL SEDIMENT AND EROSION CONTROL DEVICES SHALL BE PUT INTO PLACE PRIOR TO BEGINNING ANY CONSTRUCTION OR DEMOLITION. REFER TO PLAN FOR APPROXIMATE LOCATION OF EROSION AND SEDIMENT CONTROL. REFER TO SPECS AND DETAILS FOR TYPE OF EROSION AND SEDIMENT CONTROL.
- THE CONTRACTOR SHALL BE RESPONSIBLE FOR THE CONTINUAL MAINTENANCE OF ALL CONTROL DEVICES THROUGHOUT THE DURATION OF THE PROJECT.
- CONTRACTOR SHALL MEET ALL OF THE STATE OF MASSACHUSETTS D.E.P. AND THE TOWN OF FOXBOROUGH WETLANDS PROTECTION REGULATIONS FOR SEDIMENT AND EROSION CONTROL.
- 4. EXCAVATED MATERIAL STOCKPILED ON THE SITE SHALL BE SURROUNDED BY A RING OF UNBROKEN SEDIMENT AND EROSION CONTROL FENCE. THE LIMITS OF ALL GRADING AND DISTURBANCE SHALL BE KEPT TO A MINIMUM WITHIN THE APPROVED AREA OF CONSTRUCTION. ALL AREAS OUTSIDE OF THE LIMIT OF CONTRACT SHALL REMAIN TOTALLY UNDISTURBED UNLESS OTHERWISE APPROVED BY OWNER'S REPRESENTATIVE.
- 5. ALL CATCH BASINS AND DRAIN GRATES WITHIN LIMIT OF CONTRACT SHALL BE PROTECTED WITH FILTER FABRIC DURING THE ENTIRE DURATION OF CONSTRUCTION.
- 6. EROSION CONTROL BARRIERS TO BE INSTALLED AT THE TOE OF SLOPES. SEE GRADING & DRAINAGE PLANS, NOTES, DETAILS AND SPECIFICATIONS.
- 7. ANY AREA OUTSIDE THE PROJECT LIMIT THAT IS DISTURBED SHALL BE RESTORED TO ITS ORIGINAL CONDITION AT NO COST TO THE OWNER.
- 8. THE CONTRACTOR SHALL PROVIDE DUST CONTROL FOR CONSTRUCTION OPERATIONS AS APPROVED BY OWNER.
- 9. ALL POINTS OF CONSTRUCTION EGRESS OR INGRESS SHALL BE MAINTAINED TO PREVENT TRACKING OR FLOWING OF SEDIMENT ON TO PUBLIC/PRIVATE ROADS.

- STRUCTURES.
- PUDDLING.

## **GRADING, UTILITIES & DRAINAGE NOTES**

SHALL BE PERFORMED IN ACCORDANCE WITH THE STANDARDS OF THE TOWN OF FOXBOROUGH.

THE CONTRACTOR SHALL VERIFY ALL DIMENSIONS AND GRADES ON THE GROUND AND REPORT ANY DISCREPANCIES IMMEDIATELY TO THE OWNER.

ALL GRADING IS TO BE SMOOTH AND CONTINUOUS WHERE PROPOSED GRAVEL SURFACE MEETS EXISTING SURFACE, BLEND THE TWO PAVEMENTS AND ELIMINATE ROUGH SPOTS AND ABRUPT GRADE CHANGES AND MEET LINE AND GRADE OF EXISTING CONDITIONS WITH NEW IMPROVEMENTS.

4. CONTRACTOR SHALL MAINTAIN POSITIVE DRAINAGE (1.5% MINIMUM) AWAY FROM ALL BUILDING FOUNDATIONS AND

5. CONTRACTOR SHALL ENSURE ALL AREAS ARE PROPERLY PITCHED TO DRAIN, WITH NO SURFACE WATER PONDING OR

ALL NEW WALKWAYS / ACCESS PATHS MUST CONFORM TO CURRENT AMERICANS WITH DISABILITIES ACT (ADA) REGULATIONS: WALKWAYS SHALL MAINTAIN A CROSS PITCH OF NOT MORE THAN ONE AND A HALF PERCENT (1.5%) AND THE RUNNING SLOPE (PARALLEL TO THE DIRECTION OF TRAVEL) BETWEEN 1% MIN. AND 5% MAX.

MINIMUM SLOPE ON ALL WALKWAYS WILL BE 1:100 OR 1% TO PROVIDE POSITIVE DRAINAGE. ANY DISCREPANCIES NOT ALLOWING THIS TO OCCUR SHALL BE REPORTED TO THE ENGINEER PRIOR TO CONTINUING WORK.

ALL UTILITY GRATES, COVERS OR OTHER SURFACE ELEMENTS INTENDED TO BE EXPOSED AT GRADE SHALL BE FLUSH WITH THE ADJACENT FINISHED GRADE AND ADJUSTED TO PROVIDE A SMOOTH TRANSITION AT ALL EDGES.

9. THE CONTRACTOR SHALL SET SUBGRADE ELEVATIONS TO ALLOW FOR POSITIVE DRAINAGE AND PROVIDE EROSION CONTROL DEVICES, STRUCTURES, MATERIALS AND CONSTRUCTION METHODS TO DIRECT SILT MIGRATION AWAY FROM DRAINAGE AND OTHER UTILITY SYSTEMS, PUBLIC/PRIVATE STREETS AND WORK AREAS. CLEAN BASINS REGULARLY AND AT THE END OF THE PROJECT.

10. EXCAVATION REQUIRED WITHIN PROXIMITY OF KNOWN EXISTING UTILITY LINES SHALL BE DONE BY HAND. CONTRACTOR SHALL REPAIR ANY DAMAGE TO EXISTING UTILITY LINES OR STRUCTURES INCURRED DURING CONSTRUCTION OPERATIONS AT NO COST TO THE OWNER.

11. WHERE NEW EARTHWORK MEETS EXISTING EARTHWORK, CONTRACTOR SHALL BLEND NEW EARTHWORK SMOOTHLY INTO EXISTING, PROVIDING VERTICAL CURVES OR ROUNDS AT ALL TOP AND BOTTOM OF SLOPES.

12. WHERE A SPECIFIC LIMIT OF WORK LINE IS NOT OBVIOUS OR IMPLIED, BLEND GRADES TO EXISTING CONDITIONS WITHIN 5 FEET OF PROPOSED CONTOURS. 13. RESTORE ALL DISTURBED AREAS AND LIMITS OF ALL REMOVALS TO LOAM AND SEED (L&S) UNLESS OTHERWISE NOTED.

14. SEE EARTHWORK SECTION OF SPECIFICATIONS FOR SPECIFIC EXCAVATION AND FILLING PROCEDURES.

15. FOR STRUCTURE REMODELING (REMOD), CONSTRUCTION METHODS SHALL FOLLOW MASSACHUSETTS DOT STANDARD SPEC. LATEST EDITION (SECTION 220).

## ABBREVIATIONS

BW

CC ELEV

L.P.

PCC

PRC

PVI

PVC

PVT

S.S.D. STA TC ΤW

## GENERAL

ABAN ADJ BIT. CONC. B.M. BWLL CEM. CONC. CLF CTE E.C. EOP EQ EN EV	ABANDON ADJUST BASELINE BITUMINOUS CONCRETE BENCH MARK BROKEN WHITE LANE LI CEMENT CONCRETE CHAIN LINK FENCE CONNECT TO EXISTING ELECTRICAL CONTRACT EDGE OF PAVEMENT EQUIPMENT ENTRANCE ELECTRIC VEHICLE CHA
EXIST. (OR EX.) GRAN. CURB FDN FFE	EXISTING GRANITE CURB FOUNDATION FINISHED FLOOR ELEVA
F.L. (OR F) G.C. H.C. HMA L.O.W MB M.H.B. NIC N.T.S. ₽ P.C. PROP PROT PVMT P.W.W. RC REM REMOD RL RET R&R REMOD RL RET R&R REMOD RL RET R&R RAD R.O.W. R&S SB SB/DH STKF SWEL SYEL TEMP. TYP. VIF	FLOW LINE GENERAL CONTRACTOF HANDICAP HOT MIX ASPHALT LIMIT OF WORK MAIL BOX MASSACHUSETTS HIGHY NOT IN CONTRACT NOT TO SCALE PROPERTY LINE PLUMBING CONTRACTO PROPOSED PROTECT PAVEMENT PAVED WATERWAY REINFORCED CONCRET REMOVE REMODEL ROOF LEADER RETAIN REMOVE AND RESET REMOVE, RELOCATED A REMOVE AND RESET REMOVE, RELOCATED A REMOVE AND DISPOSE RIGHT-OF-WAY REMOVE AND STACK STONE BOUND STONE BOUND/ DRILL H STOCKADE FENCE SOLID WHITE EDGE LINE SOLID YELLOW EDGE LI
WCR	WHEELCHAIR RAMP

## UTILITIES

CCM PIPE	ASPHALT COATED CORRUGA
В	CATCH BASIN
BCI	CATCH BASIN W/ CURB INLET
	CURB INLET
I	CAST IRON
I.T.	CHANGE IN TYPE
IP	CAST IRON PIPE
MP	CORRUGATED METAL PIPE
0	CLEANOUT
l	DUCTILE IRON PIPE
MH	DRAIN MANHOLE
S	DOWN SPOUT
ICI	GUTTER INLET W/ CURB INLE
&C	FRAME AND COVER
\$G	FRAME AND GRATE
I	GUTTER INLET
V	GATE VALVE
W	GARAGE WASTE
DPE	HIGH DENSITY POLYETHYLEI
H	HANDHOLE
YD	HYDRANT
IV. ELEV.	
3	
C G	
	LIGHT POLE
CS	OUTLET CONTROL STRUCTU
GT HW	OIL AND GRIT TRAP OVERHEAD WIRE
HVV VC	POLYVINYL CHLORIDE
VC CP	REINFORCED CONCRETE PIF
MH	SEWER MANHOLE
WTU	SEWER MANHOLE STORM WATER TREATMENT
P	UTILITY POLE
r PLP	UTILITY POLE WITH LIGHT
C	VITRIFIED CLAY PIPE
/G	WATER GATE
0	

### ALIGNMENT/GRADING

BOTTOM OF CURB
BOTTOM OF WALL
CENTER OF CURVE
ELEVATION
LOW POINT
HIGH POINT
POINT OF CURVATURE
POINT OF COMPOUND CURVATUR
POINT OF INTERSECTION
POINT OF TANGENCY
POINT OF REVERSE CURVATURE
POINT OF VERTICAL INTERSECTION
POINT OF VERTICAL CURVATURE
POINT OF VERTICAL TANGENCY
RADIUS OF CURVATURE
STOPPING SIGHT DISTANCE
STATION
TOP OF CURB
TOP OF WALL

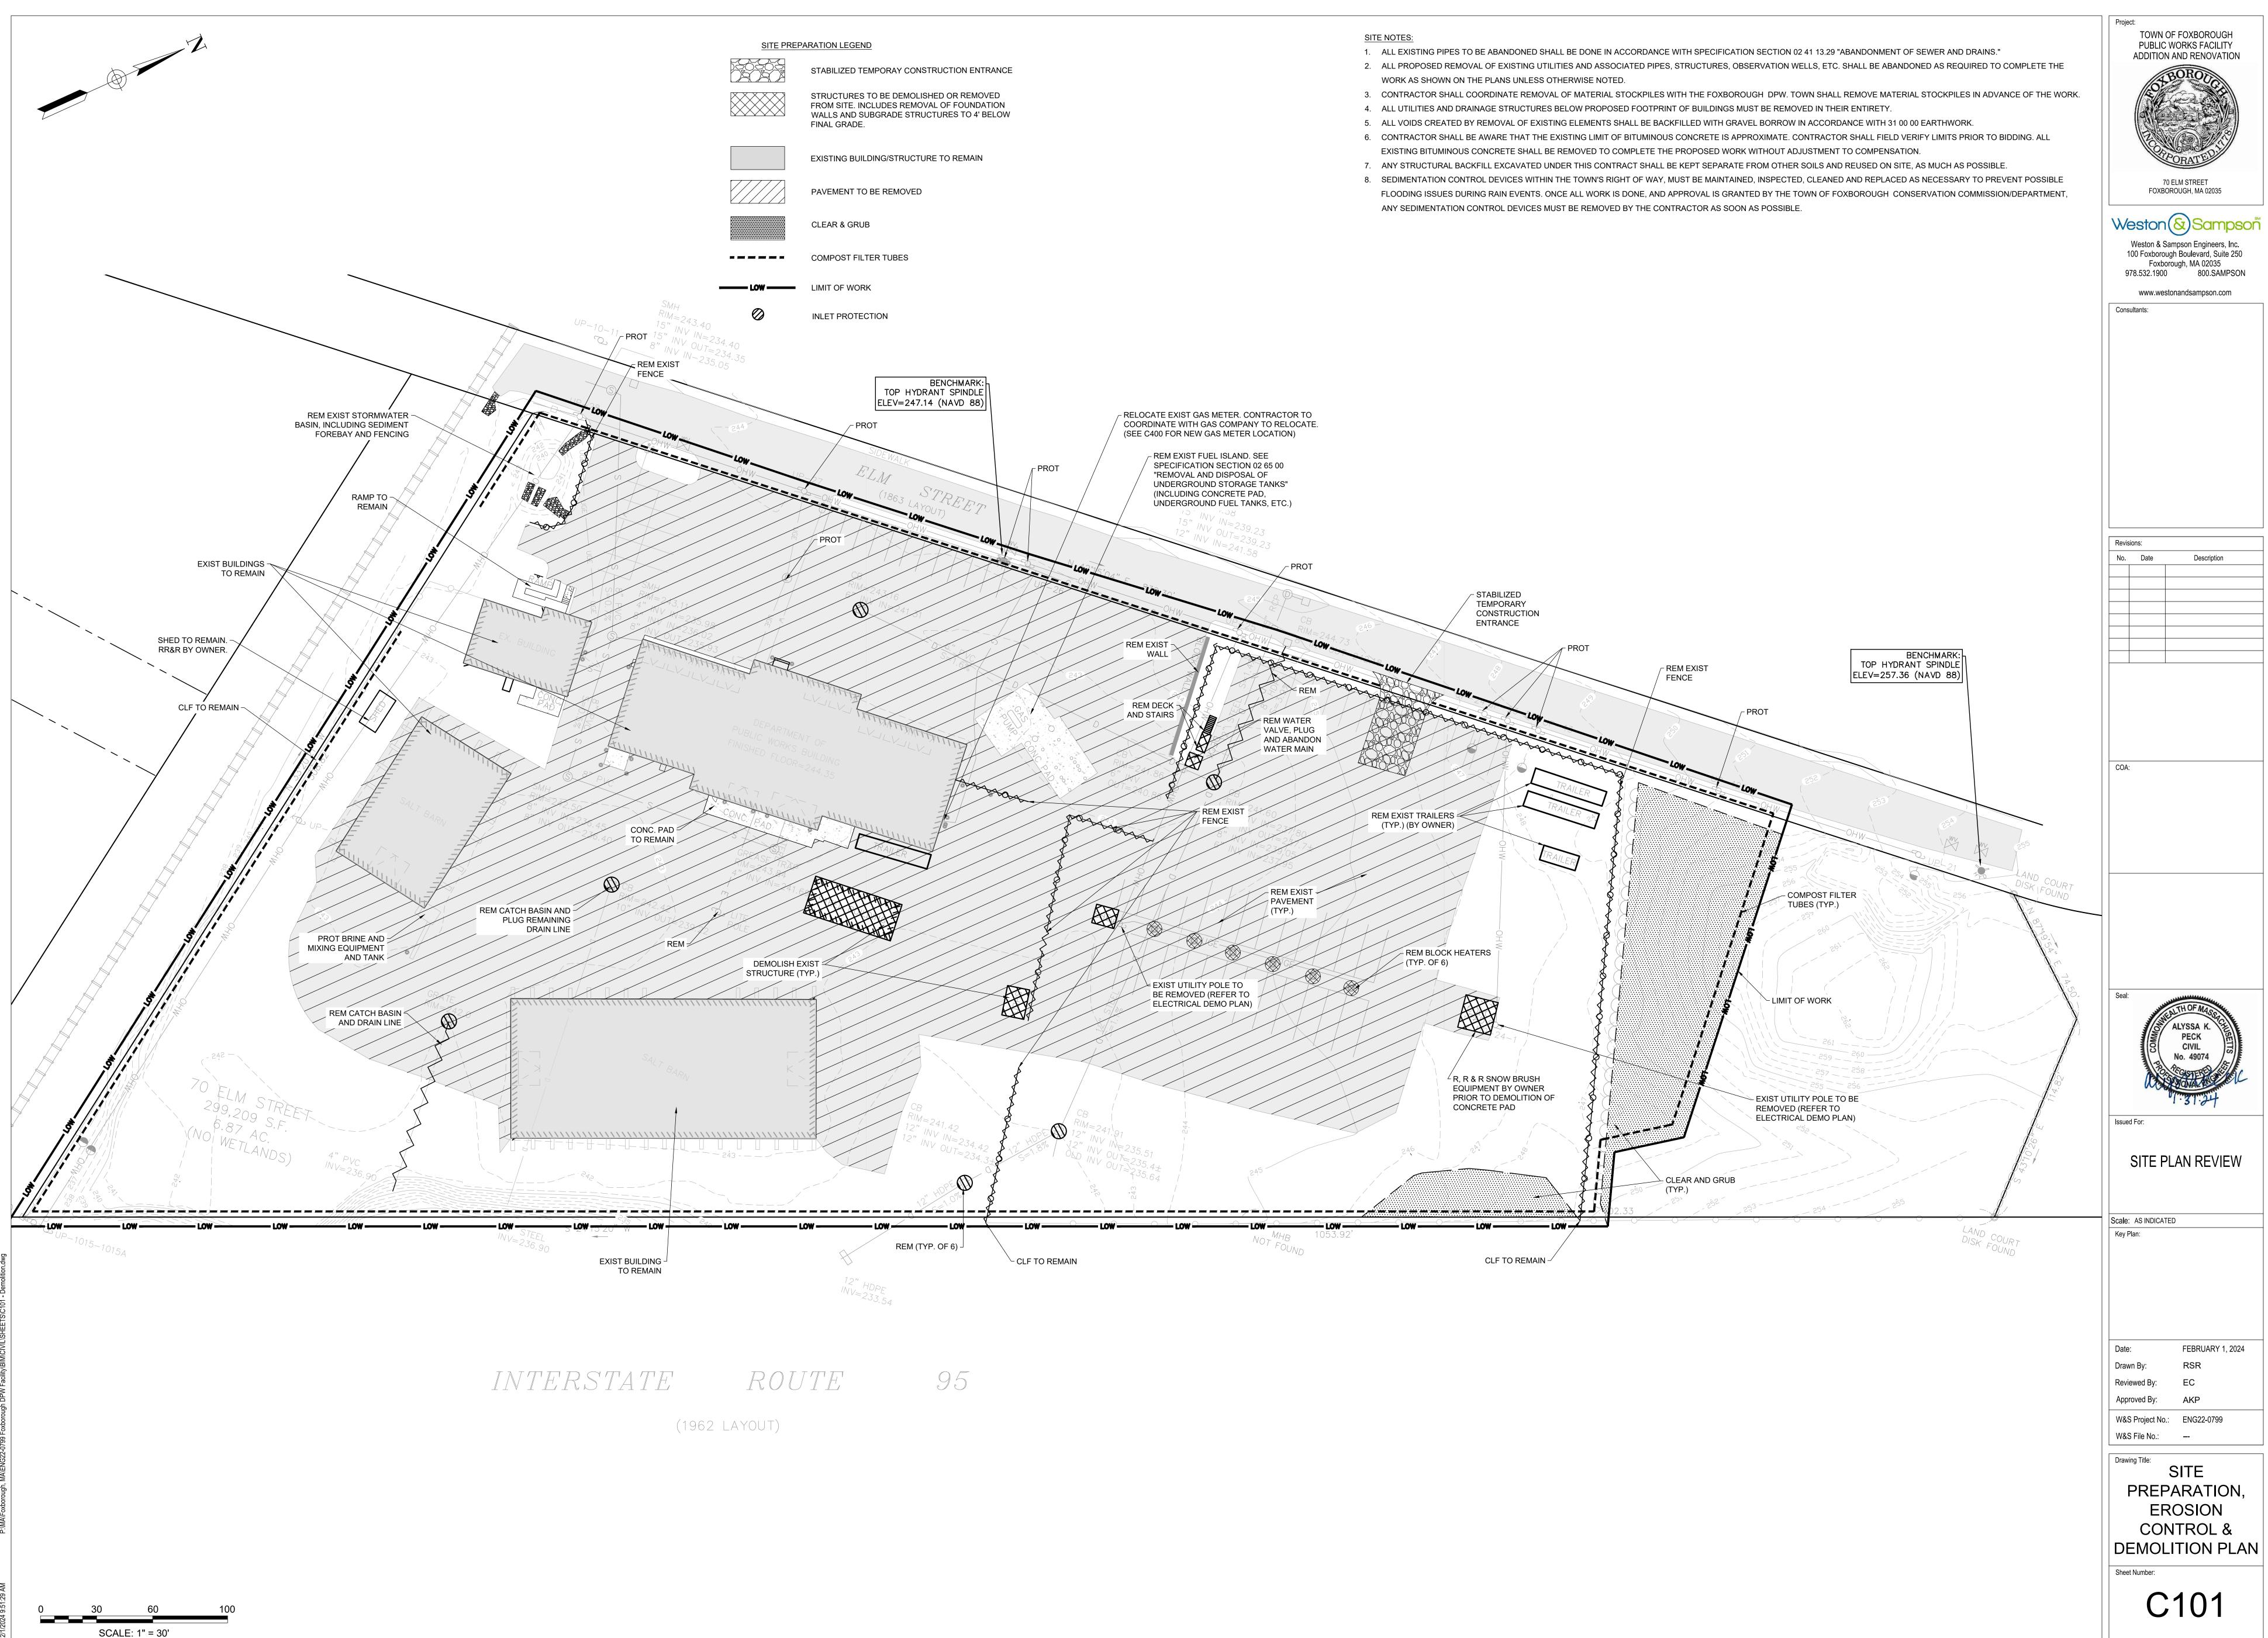
## GENERAL SYMBOLS



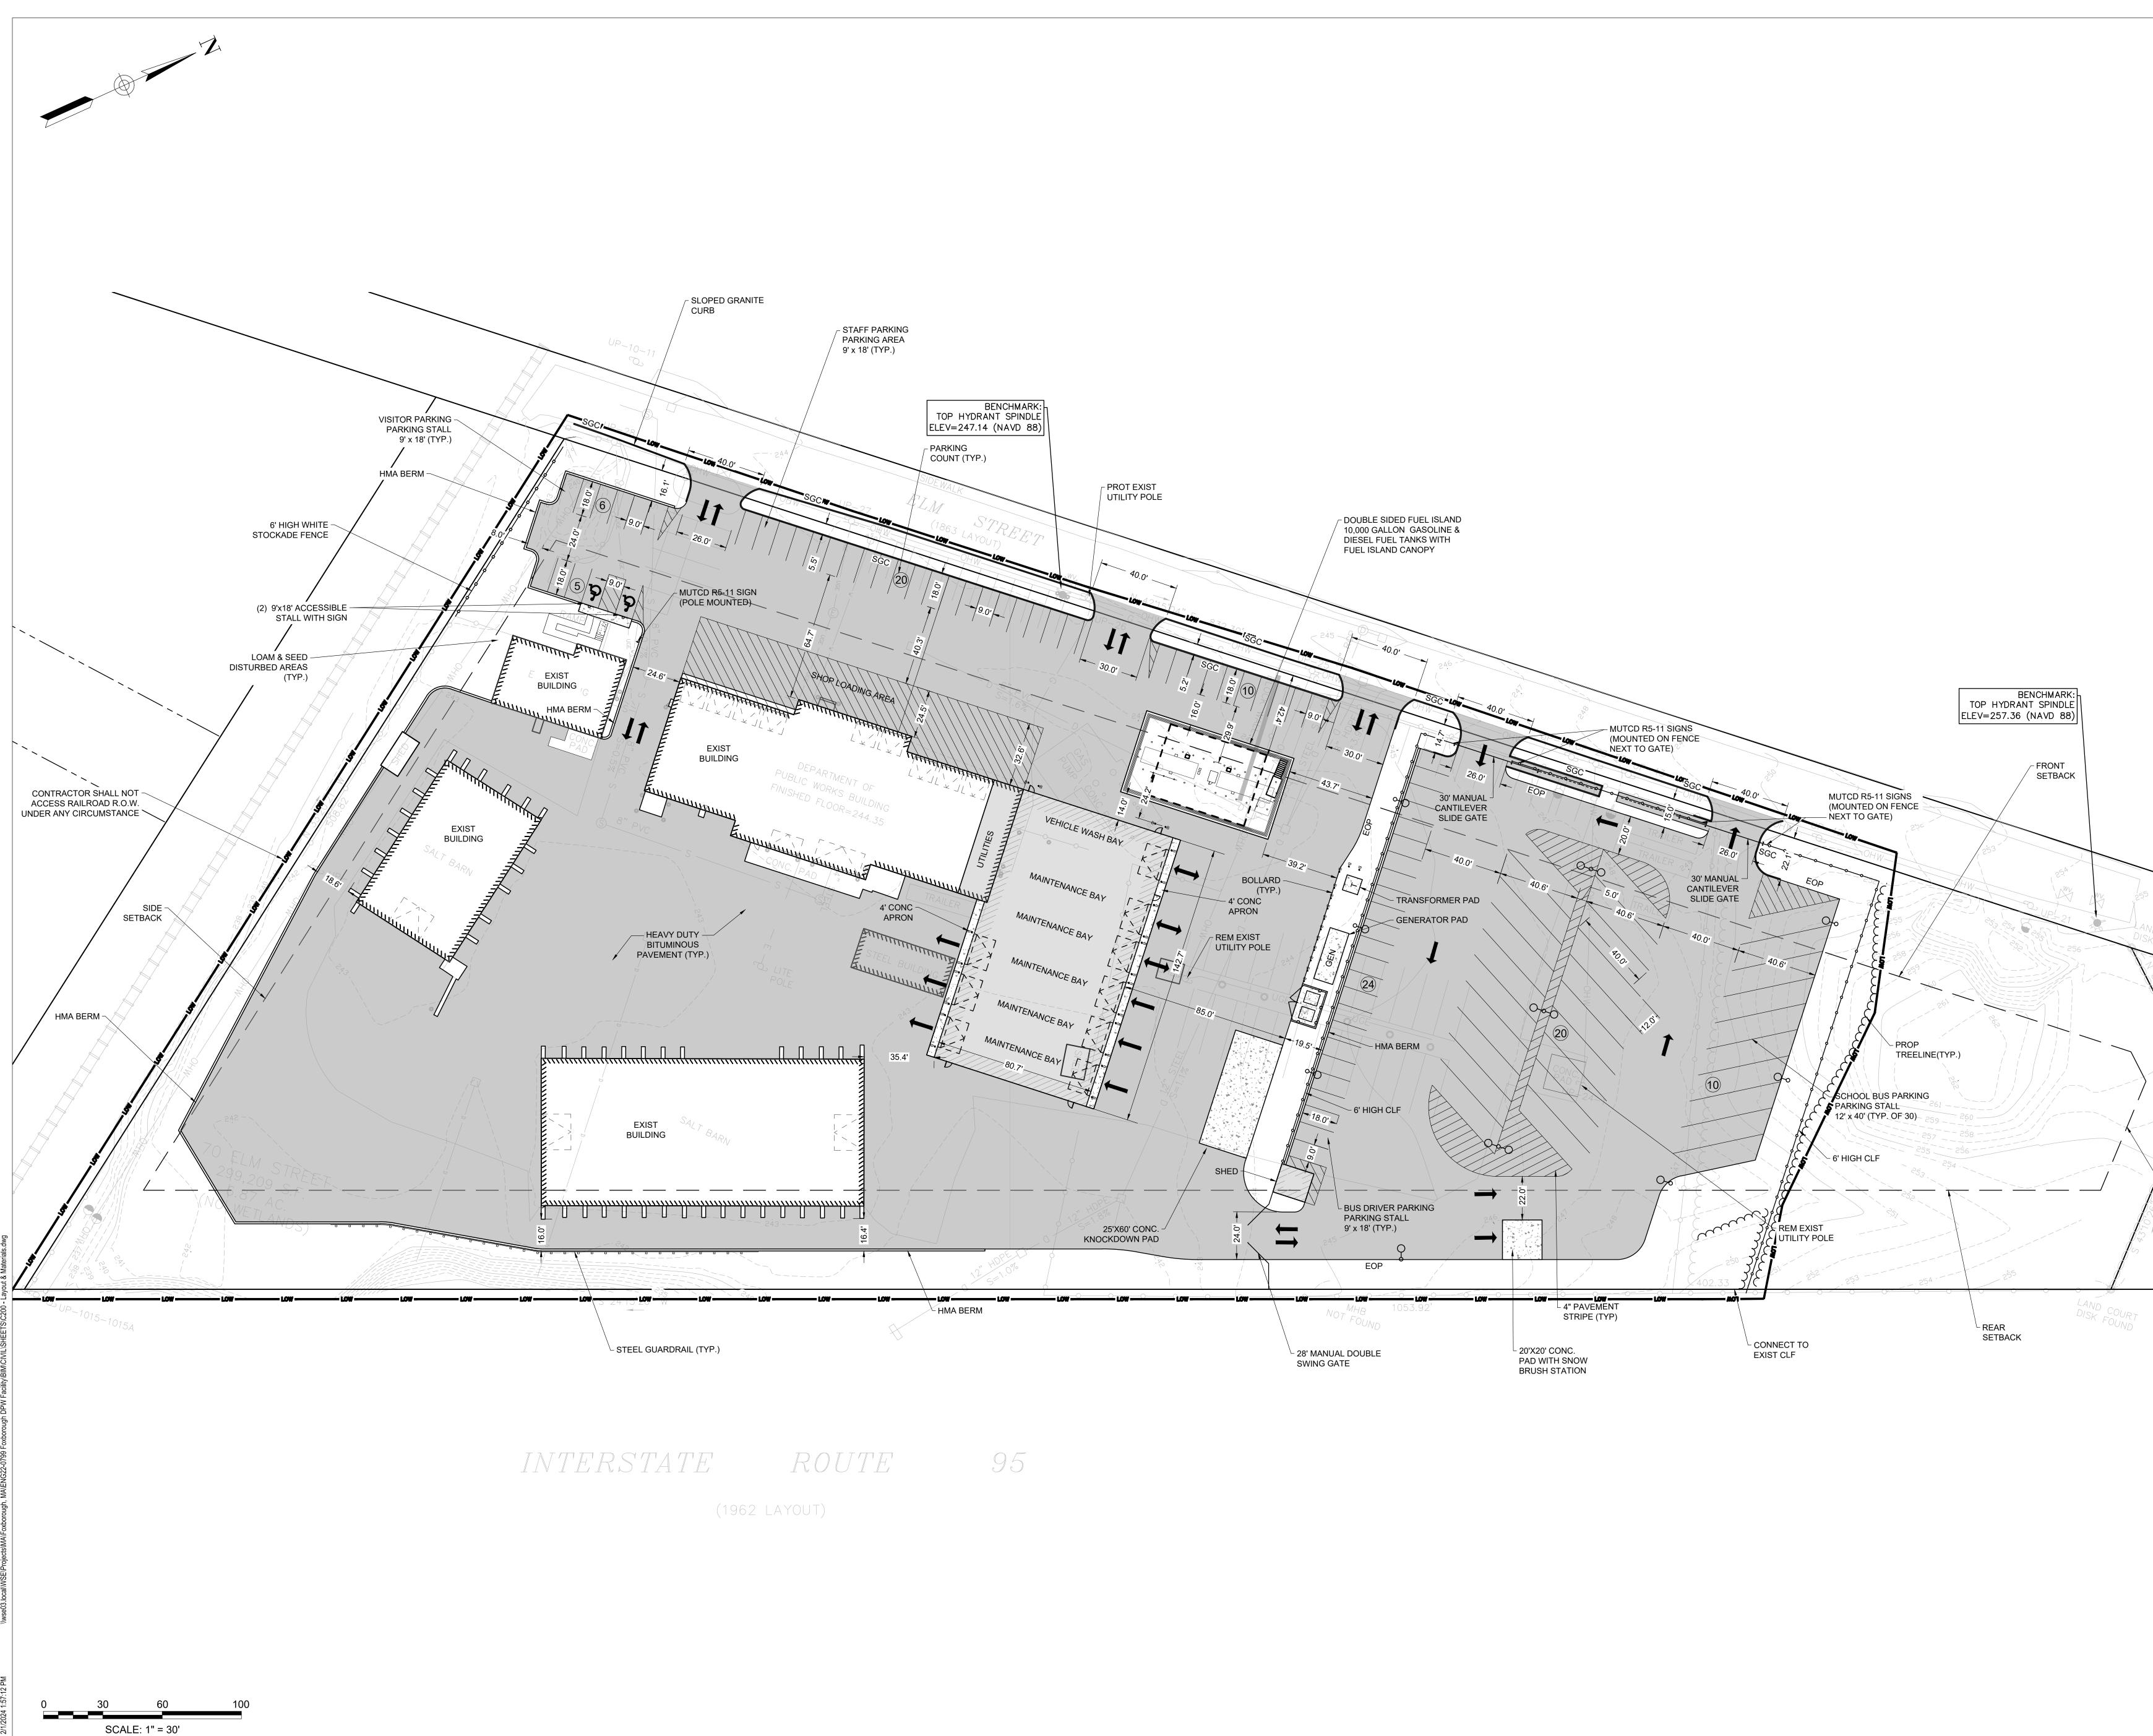
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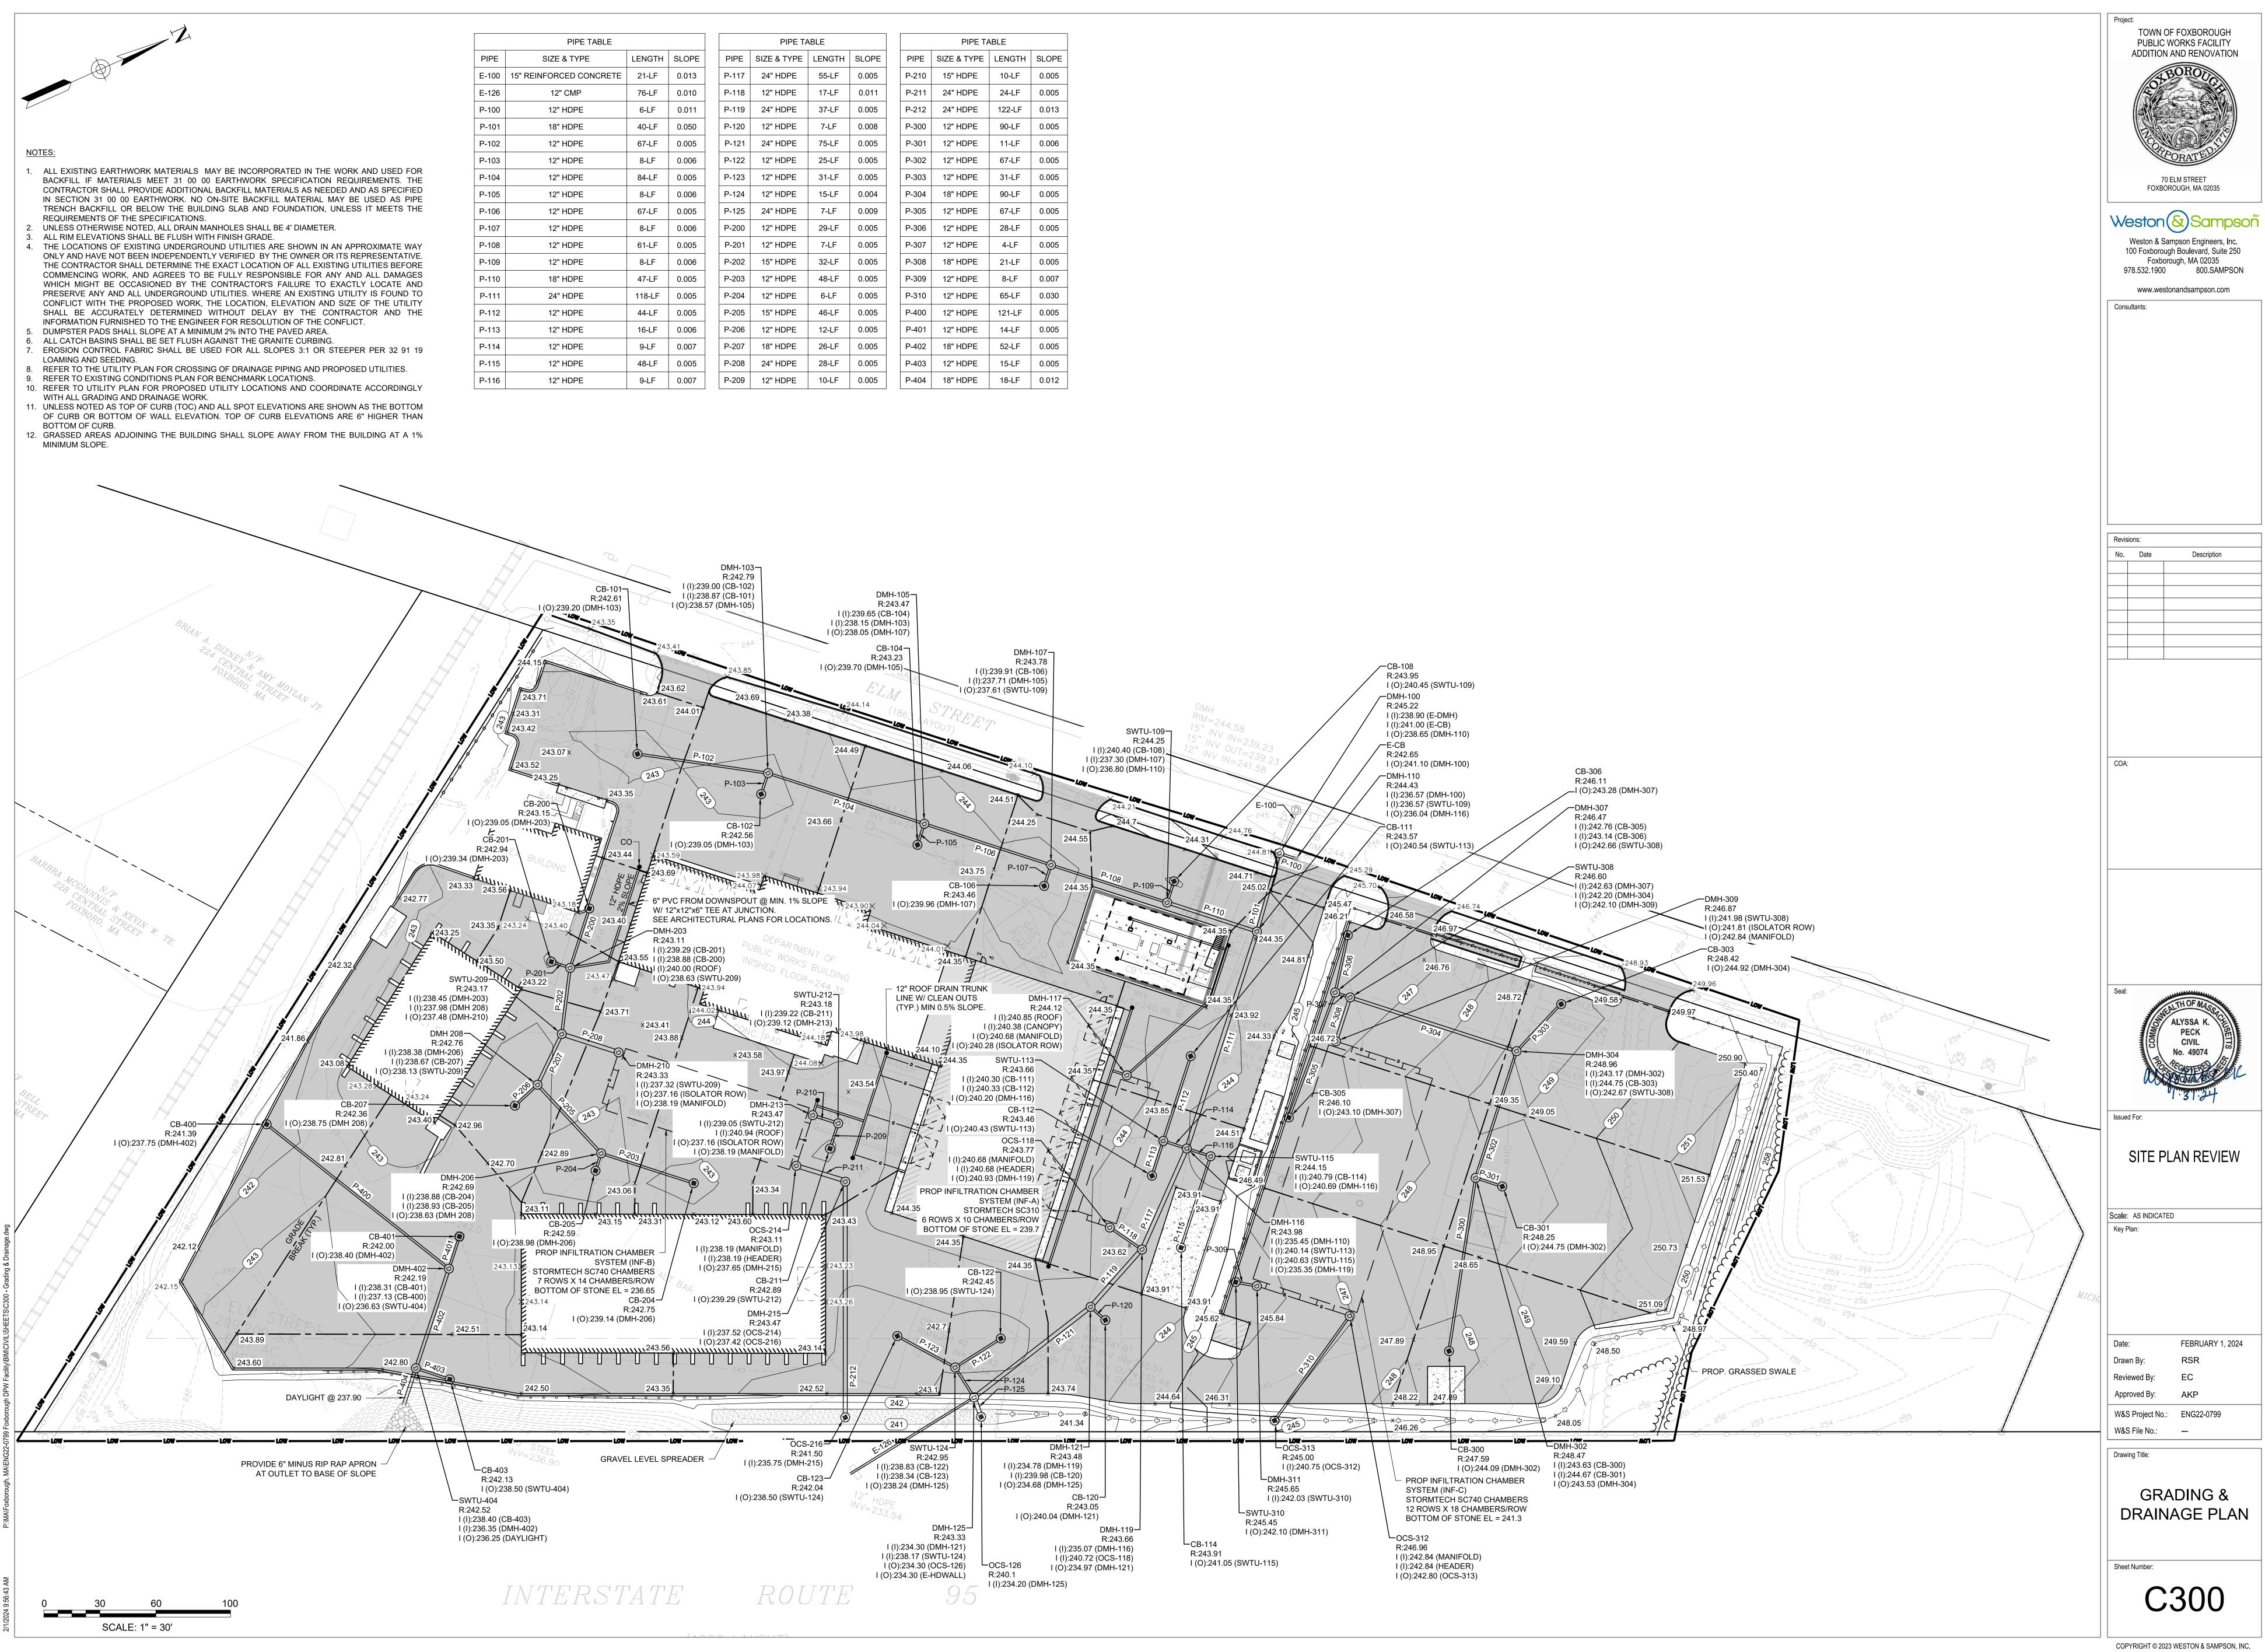
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ADDITION AND RENOVATION						
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70 ELM STREET						
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Revisions:						
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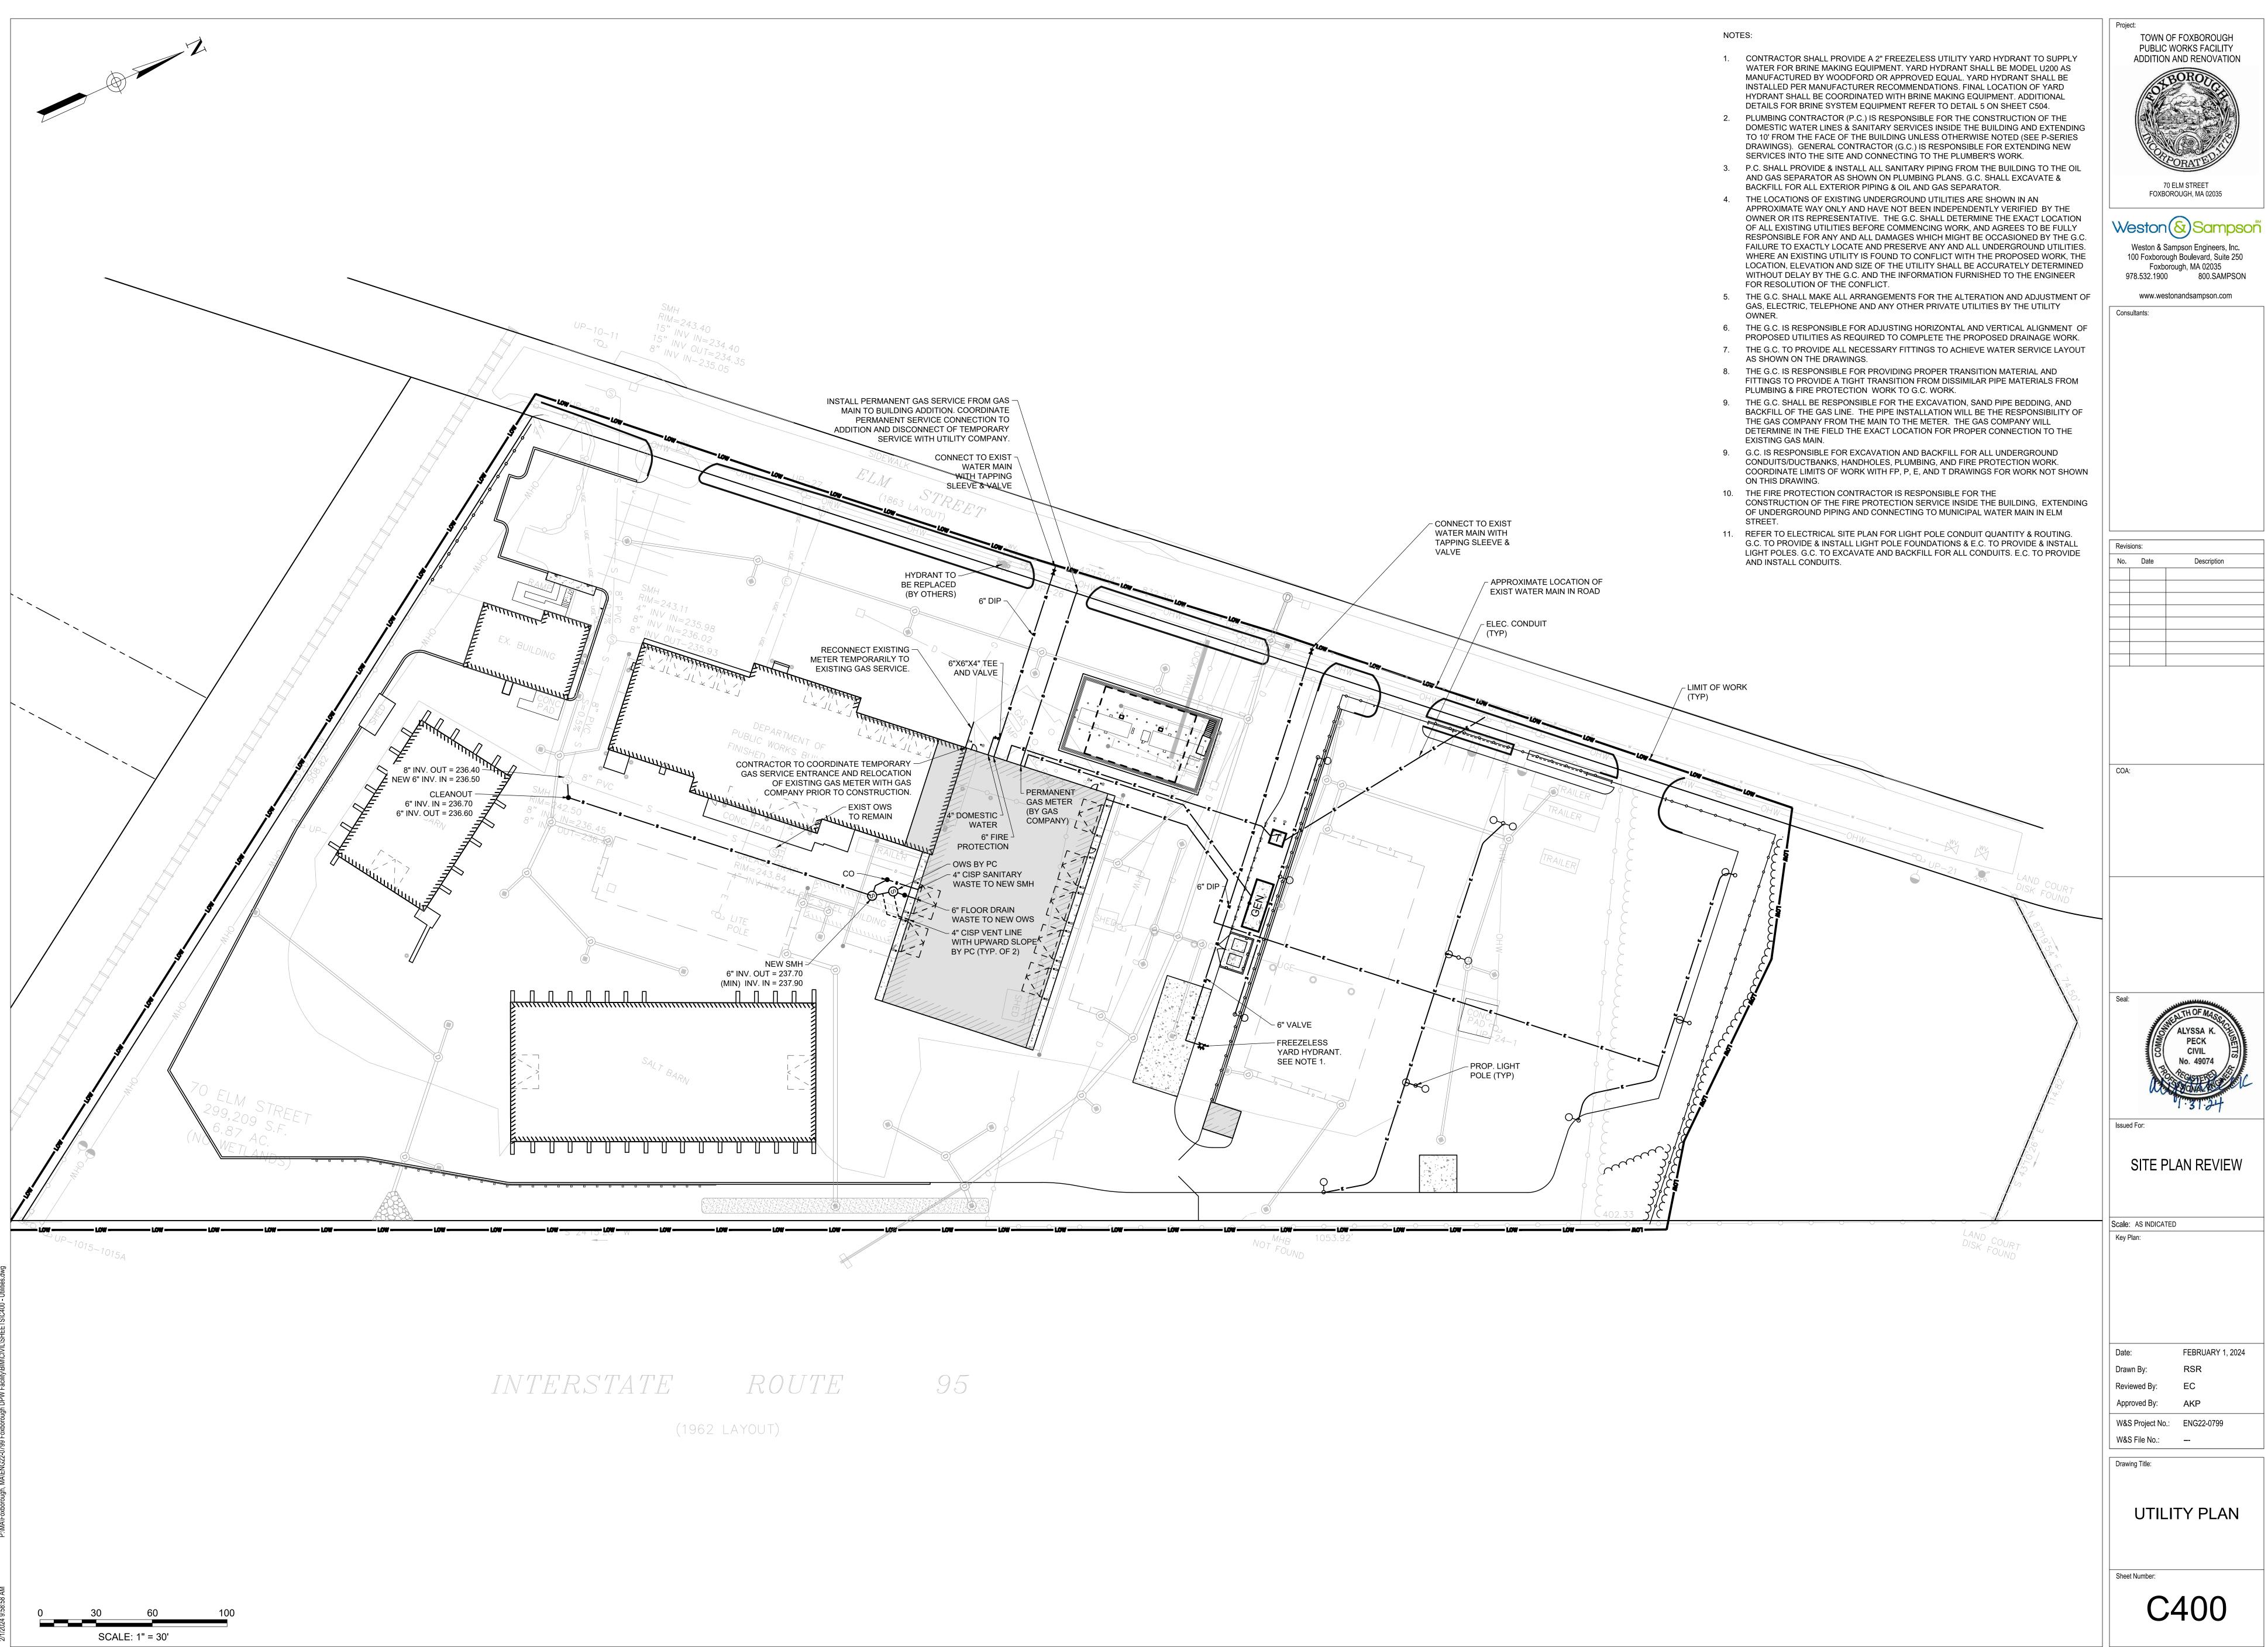
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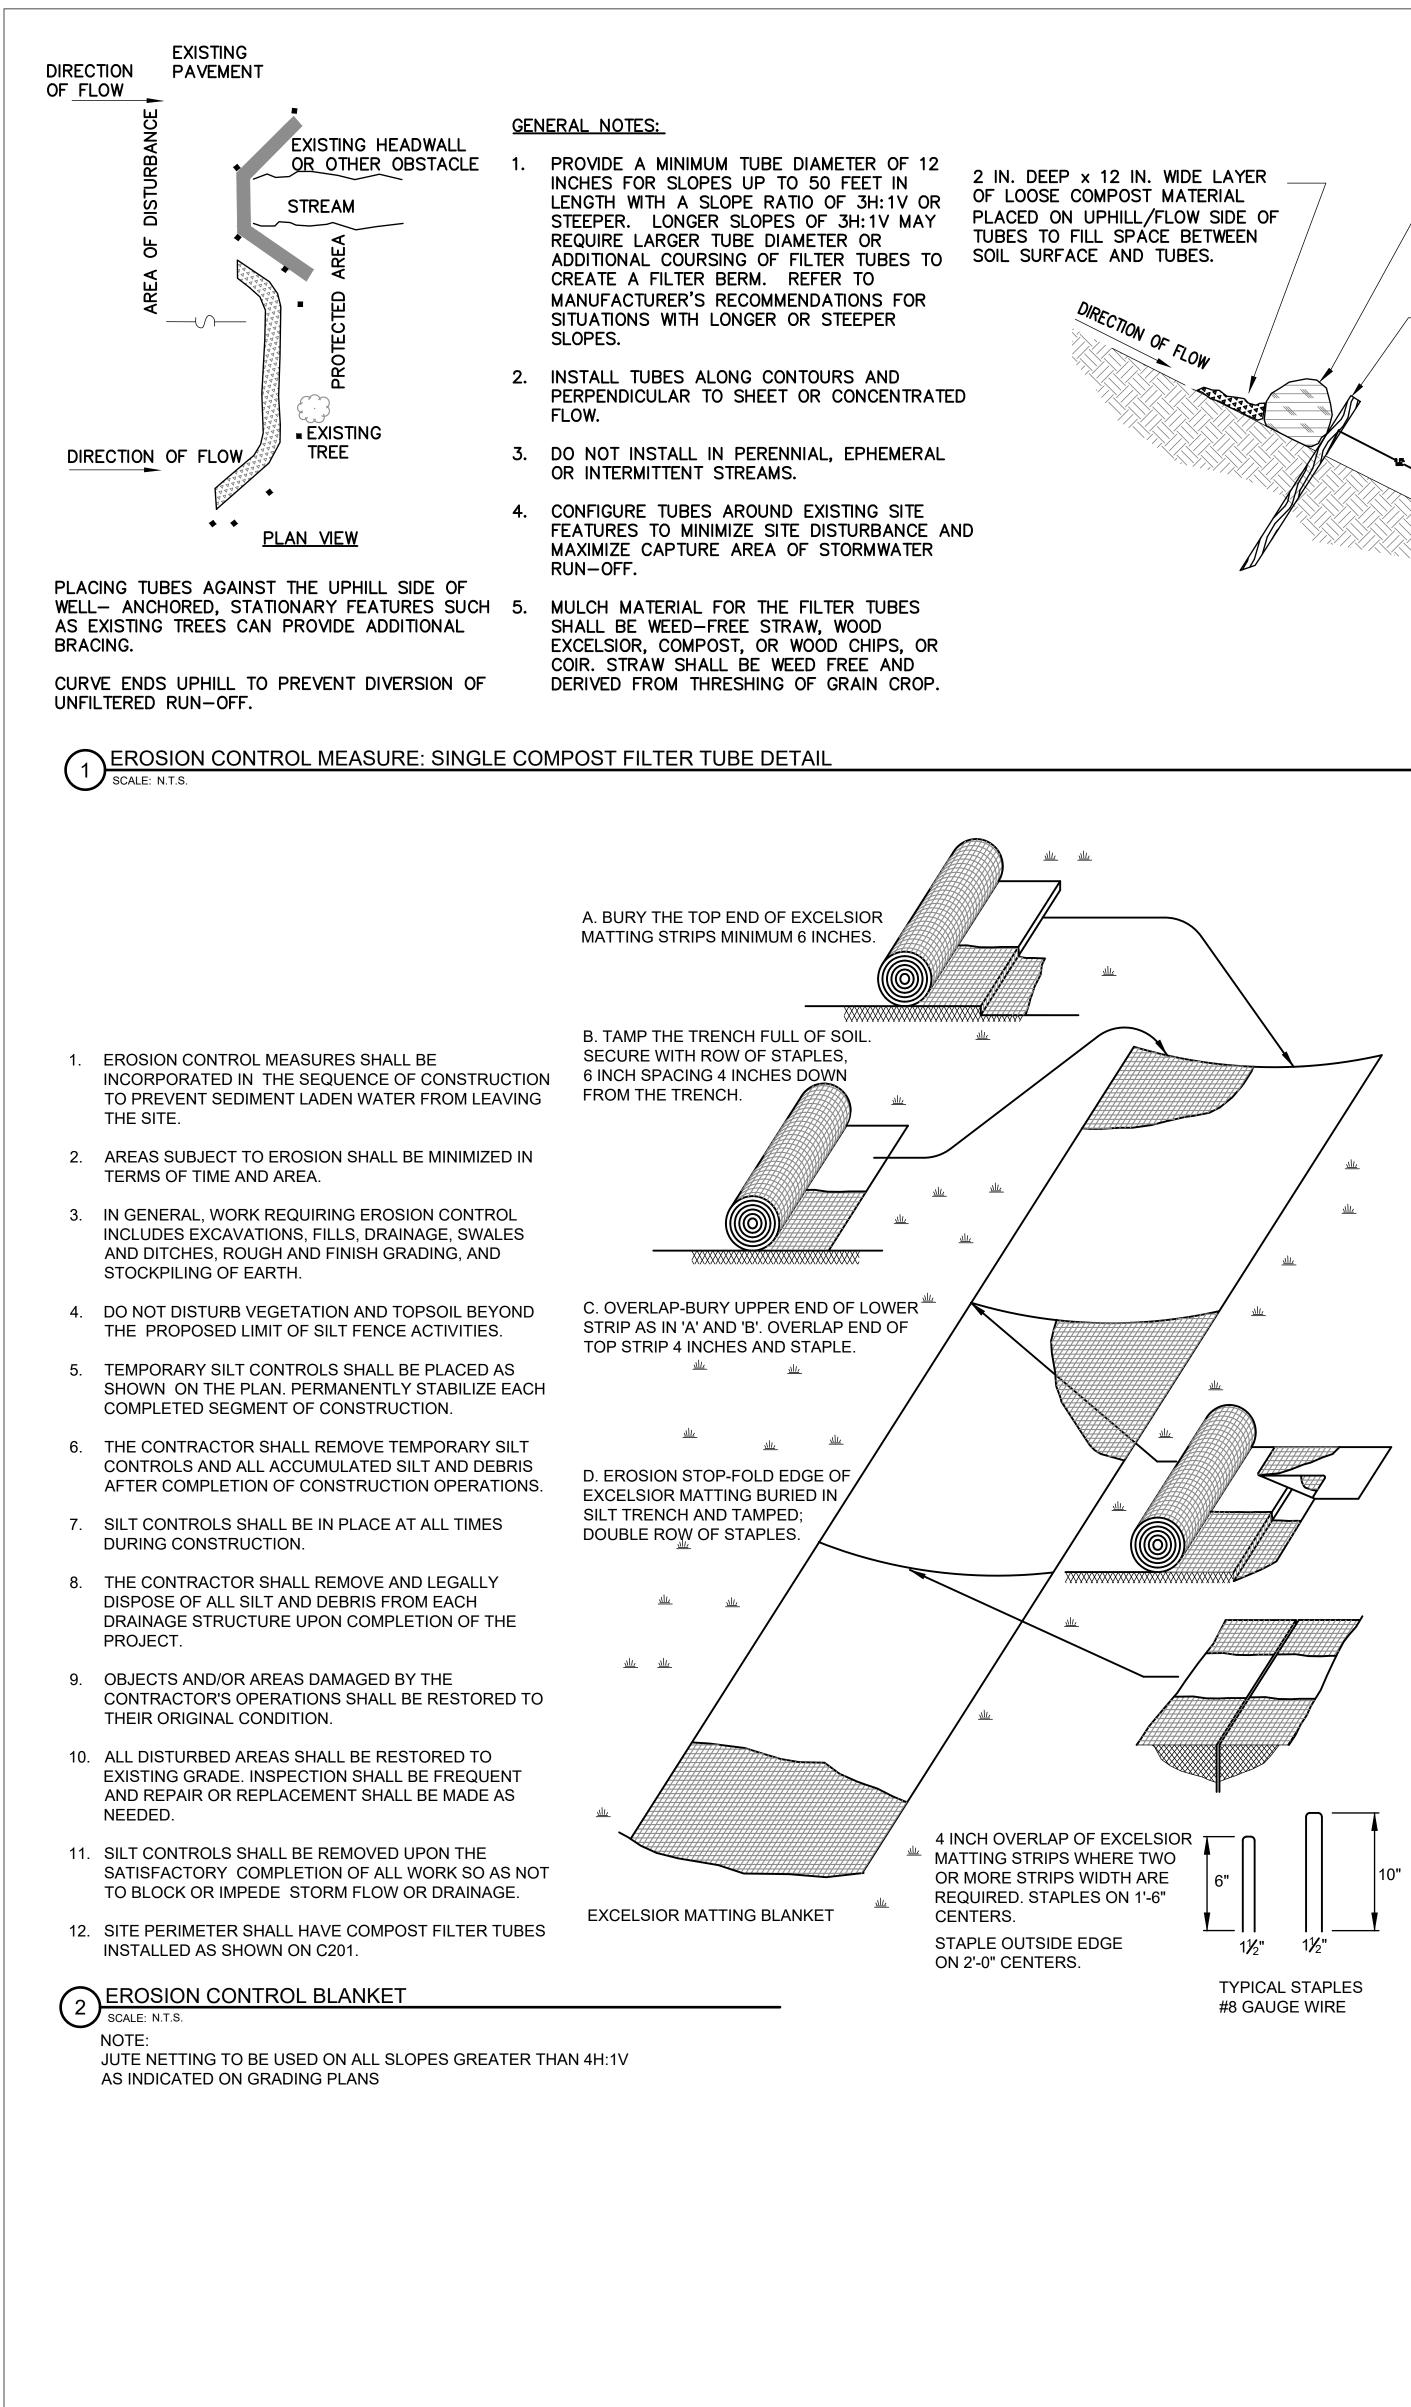
Project: TOWN OF FOXBOROUGH PUBLIC WORKS FACILITY ADDITION AND RENOVATION 70 ELM STREET FOXBOROUGH, MA 02035 Weston & Sampson Weston & Sampson Engineers, Inc. 100 Foxborough Boulevard, Suite 250 Foxborough, MA 02035 978.532.1900 800.SAMPSON www.westonandsampson.com Consultants: Revisions: No. Date Description COA: Seal: 🖌 ALYSSA K PECK CIVIL No. 49074 1.31.2 Issued For: - SIDE SETBACK SITE PLAN REVIEW Scale: AS INDICATED Key Plan: FEBRUARY 1, 2024 Date: RSR Drawn By: EC Reviewed By: Approved By: AKP W&S Project No.: ENG22-0799 W&S File No.: --Drawing Title: LAYOUT & MATERIALS PLAN Sheet Number: C200 COPYRIGHT © 2023 WESTON & SAMPSON, INC.

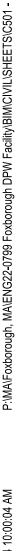


			PIPE TA	ABLE			PIPE TA	ABLE	
LENGTH	SLOPE	PIPE	SIZE & TYPE	LENGTH	SLOPE	PIPE	SIZE & TYPE	LENGTH	SLOPE
21-LF	0.013	P-117	24" HDPE	55-LF	0.005	P-210	15" HDPE	10-LF	0.005
76-LF	0.010	P-118	12" HDPE	17-LF	0.011	P-211	24" HDPE	24-LF	0.005
6-LF	0.011	P-119	24" HDPE	37-LF	0.005	P-212	24" HDPE	122-LF	0.013
40-LF	0.050	P-120	12" HDPE	7-LF	0.008	P-300	12" HDPE	90-LF	0.005
67-LF	0.005	P-121	24" HDPE	75-LF	0.005	P-301	12" HDPE	11-LF	0.006
8-LF	0.006	P-122	12" HDPE	25-LF	0.005	P-302	12" HDPE	67-LF	0.005
84-LF	0.005	P-123	12" HDPE	31-LF	0.005	P-303	12" HDPE	31-LF	0.005
8-LF	0.006	P-124	12" HDPE	15-LF	0.004	P-304	18" HDPE	90-LF	0.005
67-LF	0.005	P-125	24" HDPE	7-LF	0.009	P-305	12" HDPE	67-LF	0.005
8-LF	0.006	P-200	12" HDPE	29-LF	0.005	P-306	12" HDPE	28-LF	0.005
61-LF	0.005	P-201	12" HDPE	7-LF	0.005	P-307	12" HDPE	4-LF	0.005
8-LF	0.006	P-202	15" HDPE	32-LF	0.005	P-308	18" HDPE	21-LF	0.005
47-LF	0.005	P-203	12" HDPE	48-LF	0.005	P-309	12" HDPE	8-LF	0.007
118-LF	0.005	P-204	12" HDPE	6-LF	0.005	P-310	12" HDPE	65-LF	0.030
44-LF	0.005	P-205	15" HDPE	46-LF	0.005	P-400	12" HDPE	121-LF	0.005
16-LF	0.006	P-206	12" HDPE	12-LF	0.005	P-401	12" HDPE	14-LF	0.005
9-LF	0.007	P-207	18" HDPE	26-LF	0.005	P-402	18" HDPE	52-LF	0.005
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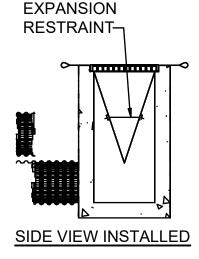


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COMPOST FILTER TUBE MINIMUM 12 INCHES IN DIAMETER WITH AN EFFECTIVE HEIGHT OF 9.5 INCHES. TUBES FOR COMPOST FILTERS SHALL BE JUTE MESH OR APPROVED BIODEGRADABLE MATERIAL. ADDITIONAL TUBES SHALL BE USED AT THE DIRECTION OF THE ENGINEER. TAMP TUBES IN PLACE TO ENSURE GOOD CONTACT WITH SOIL SURFACE. IT IS NOT NECESSARY TO TRENCH TUBES INTO EXISTING GRADE. 2 INCH X 2 INCH X 3 FEET UNTREATED HARDWOOD STAKES, UP TO 5 FT. APART OR AS REQUIRED TO SECURE TUBES IN PLACE. WHEN STAKING IS NOT POSSIBLE, SUCH AS WHEN TUBES MUST BE PLACED ON PAVEMENT, HEAVY CONCRETE OR CINDER BLOCKS CAN BE USED BEHIND TUBES UP TO 5 FT. APART OR AS REQUIRED TO SECURE TUBES IN PLACE. - LIMIT OF WORK UNDISTURBED SUBGRADE



<u>NOTE:</u> ALL NEW CATCH BASINS WITHIN THE LIMIT OF WORK SHALL HAVE INLET CONTROL UNTIL THE

1" REBAR FOR BAG

(PROVIDE REBAR)

REMOVAL FROM INLET

OPTIONAL OVERFLOW

APPROVED CATCH

(PROVIDE REBAR)

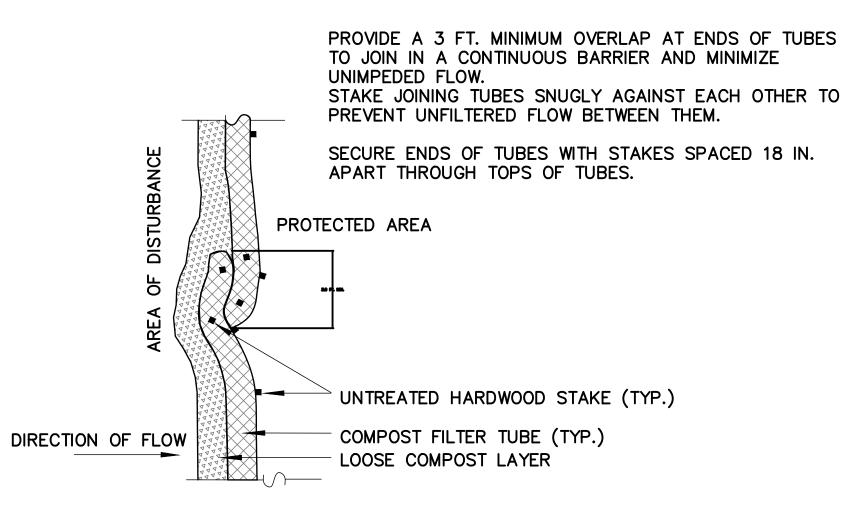
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DUMP LOOPS

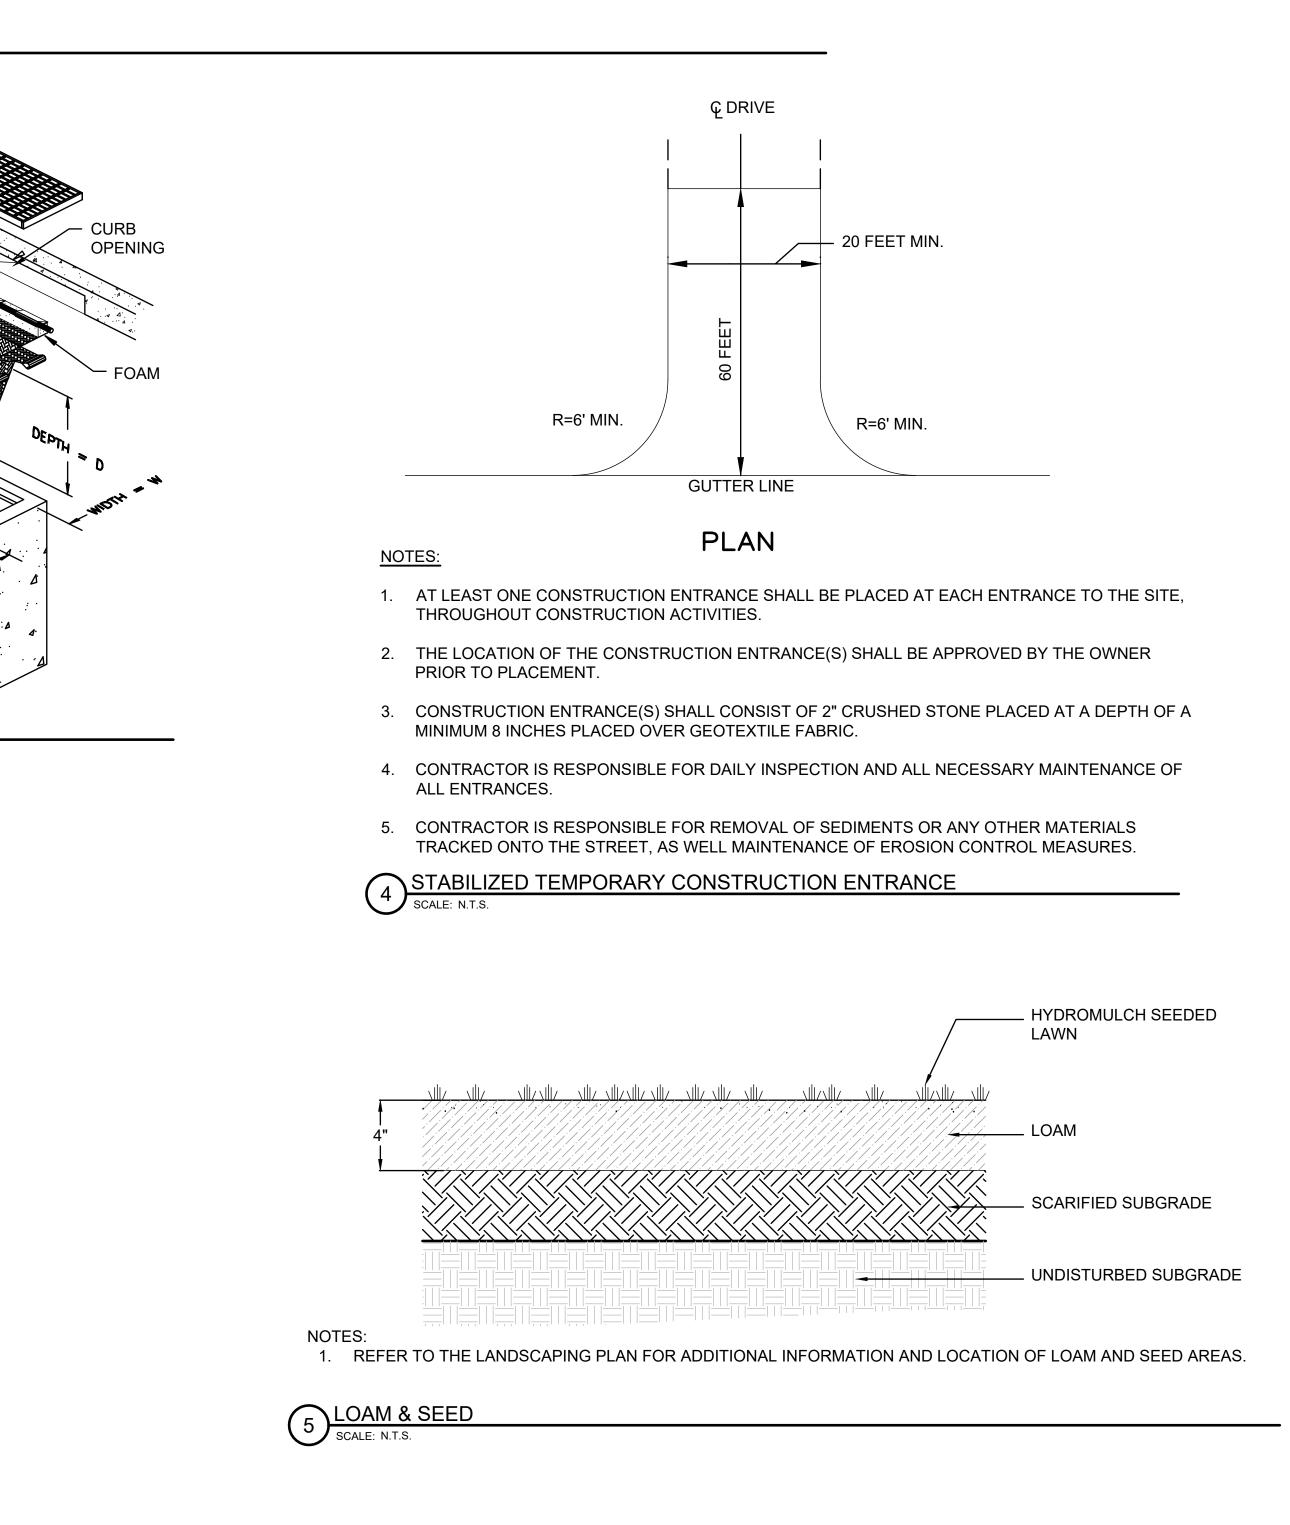
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3 INLET SEDIMENT CONTROL SCALE: N.T.S.

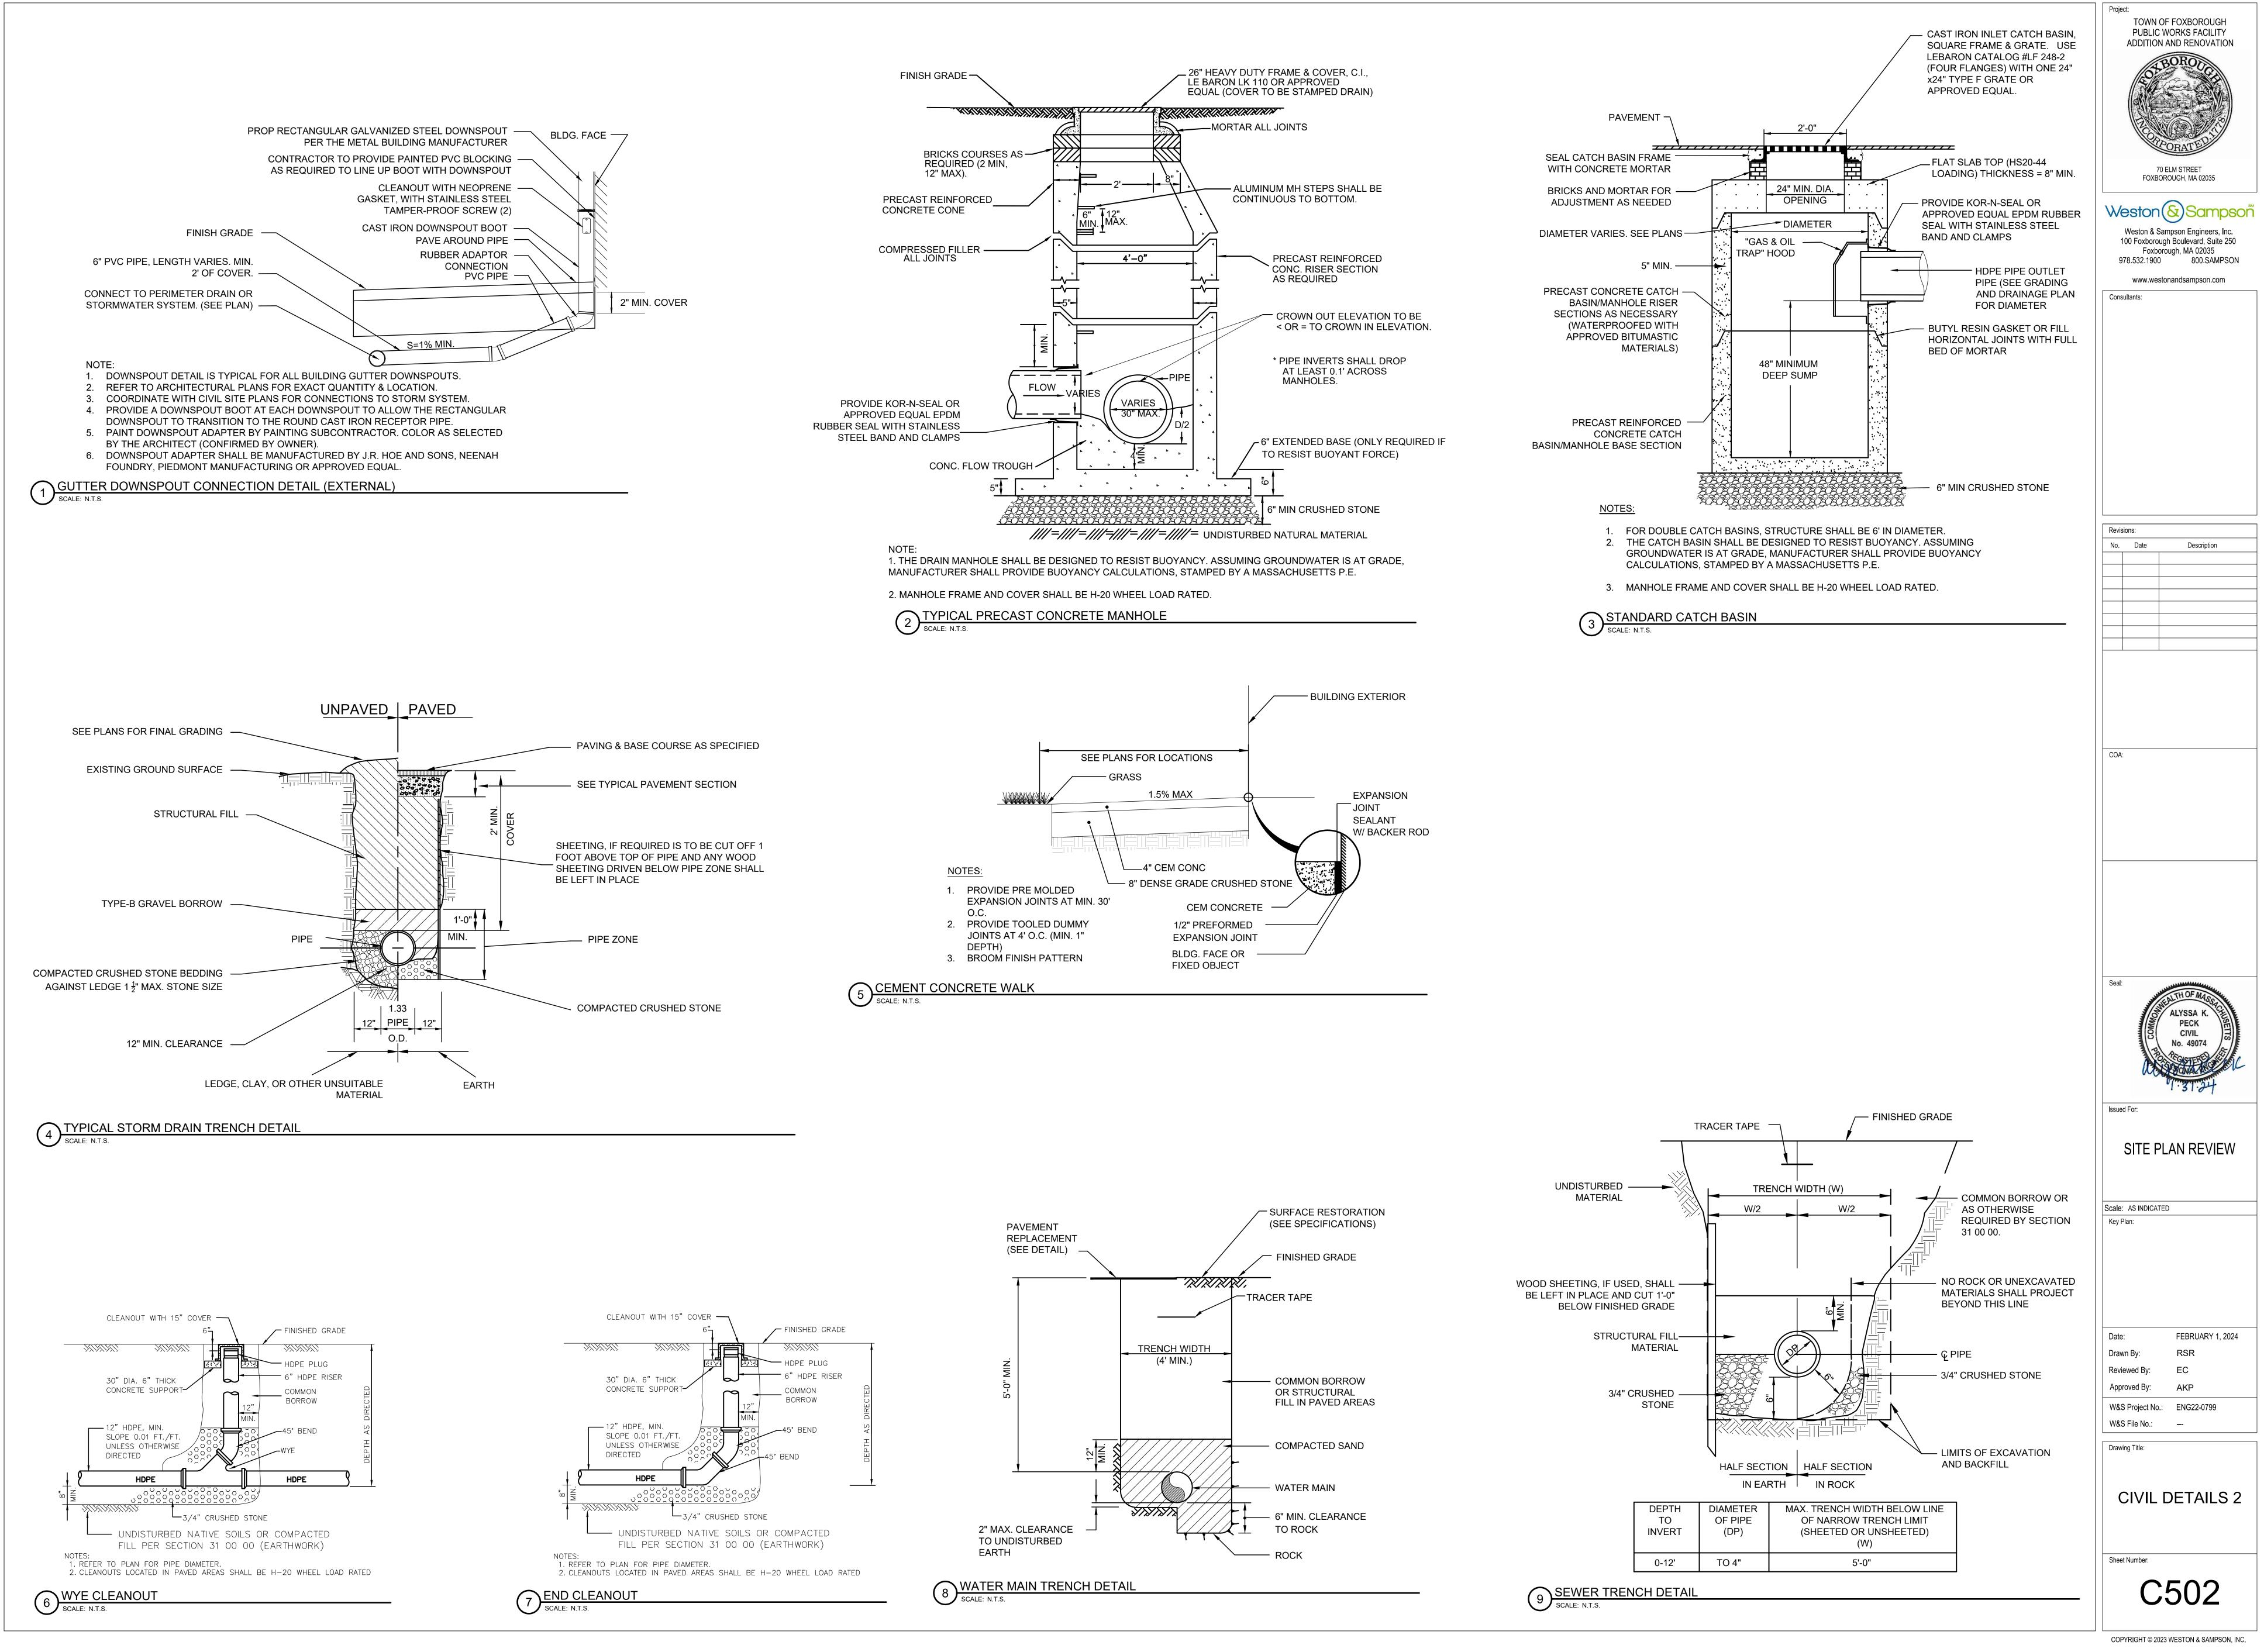
COMPLETION OF PAVING.



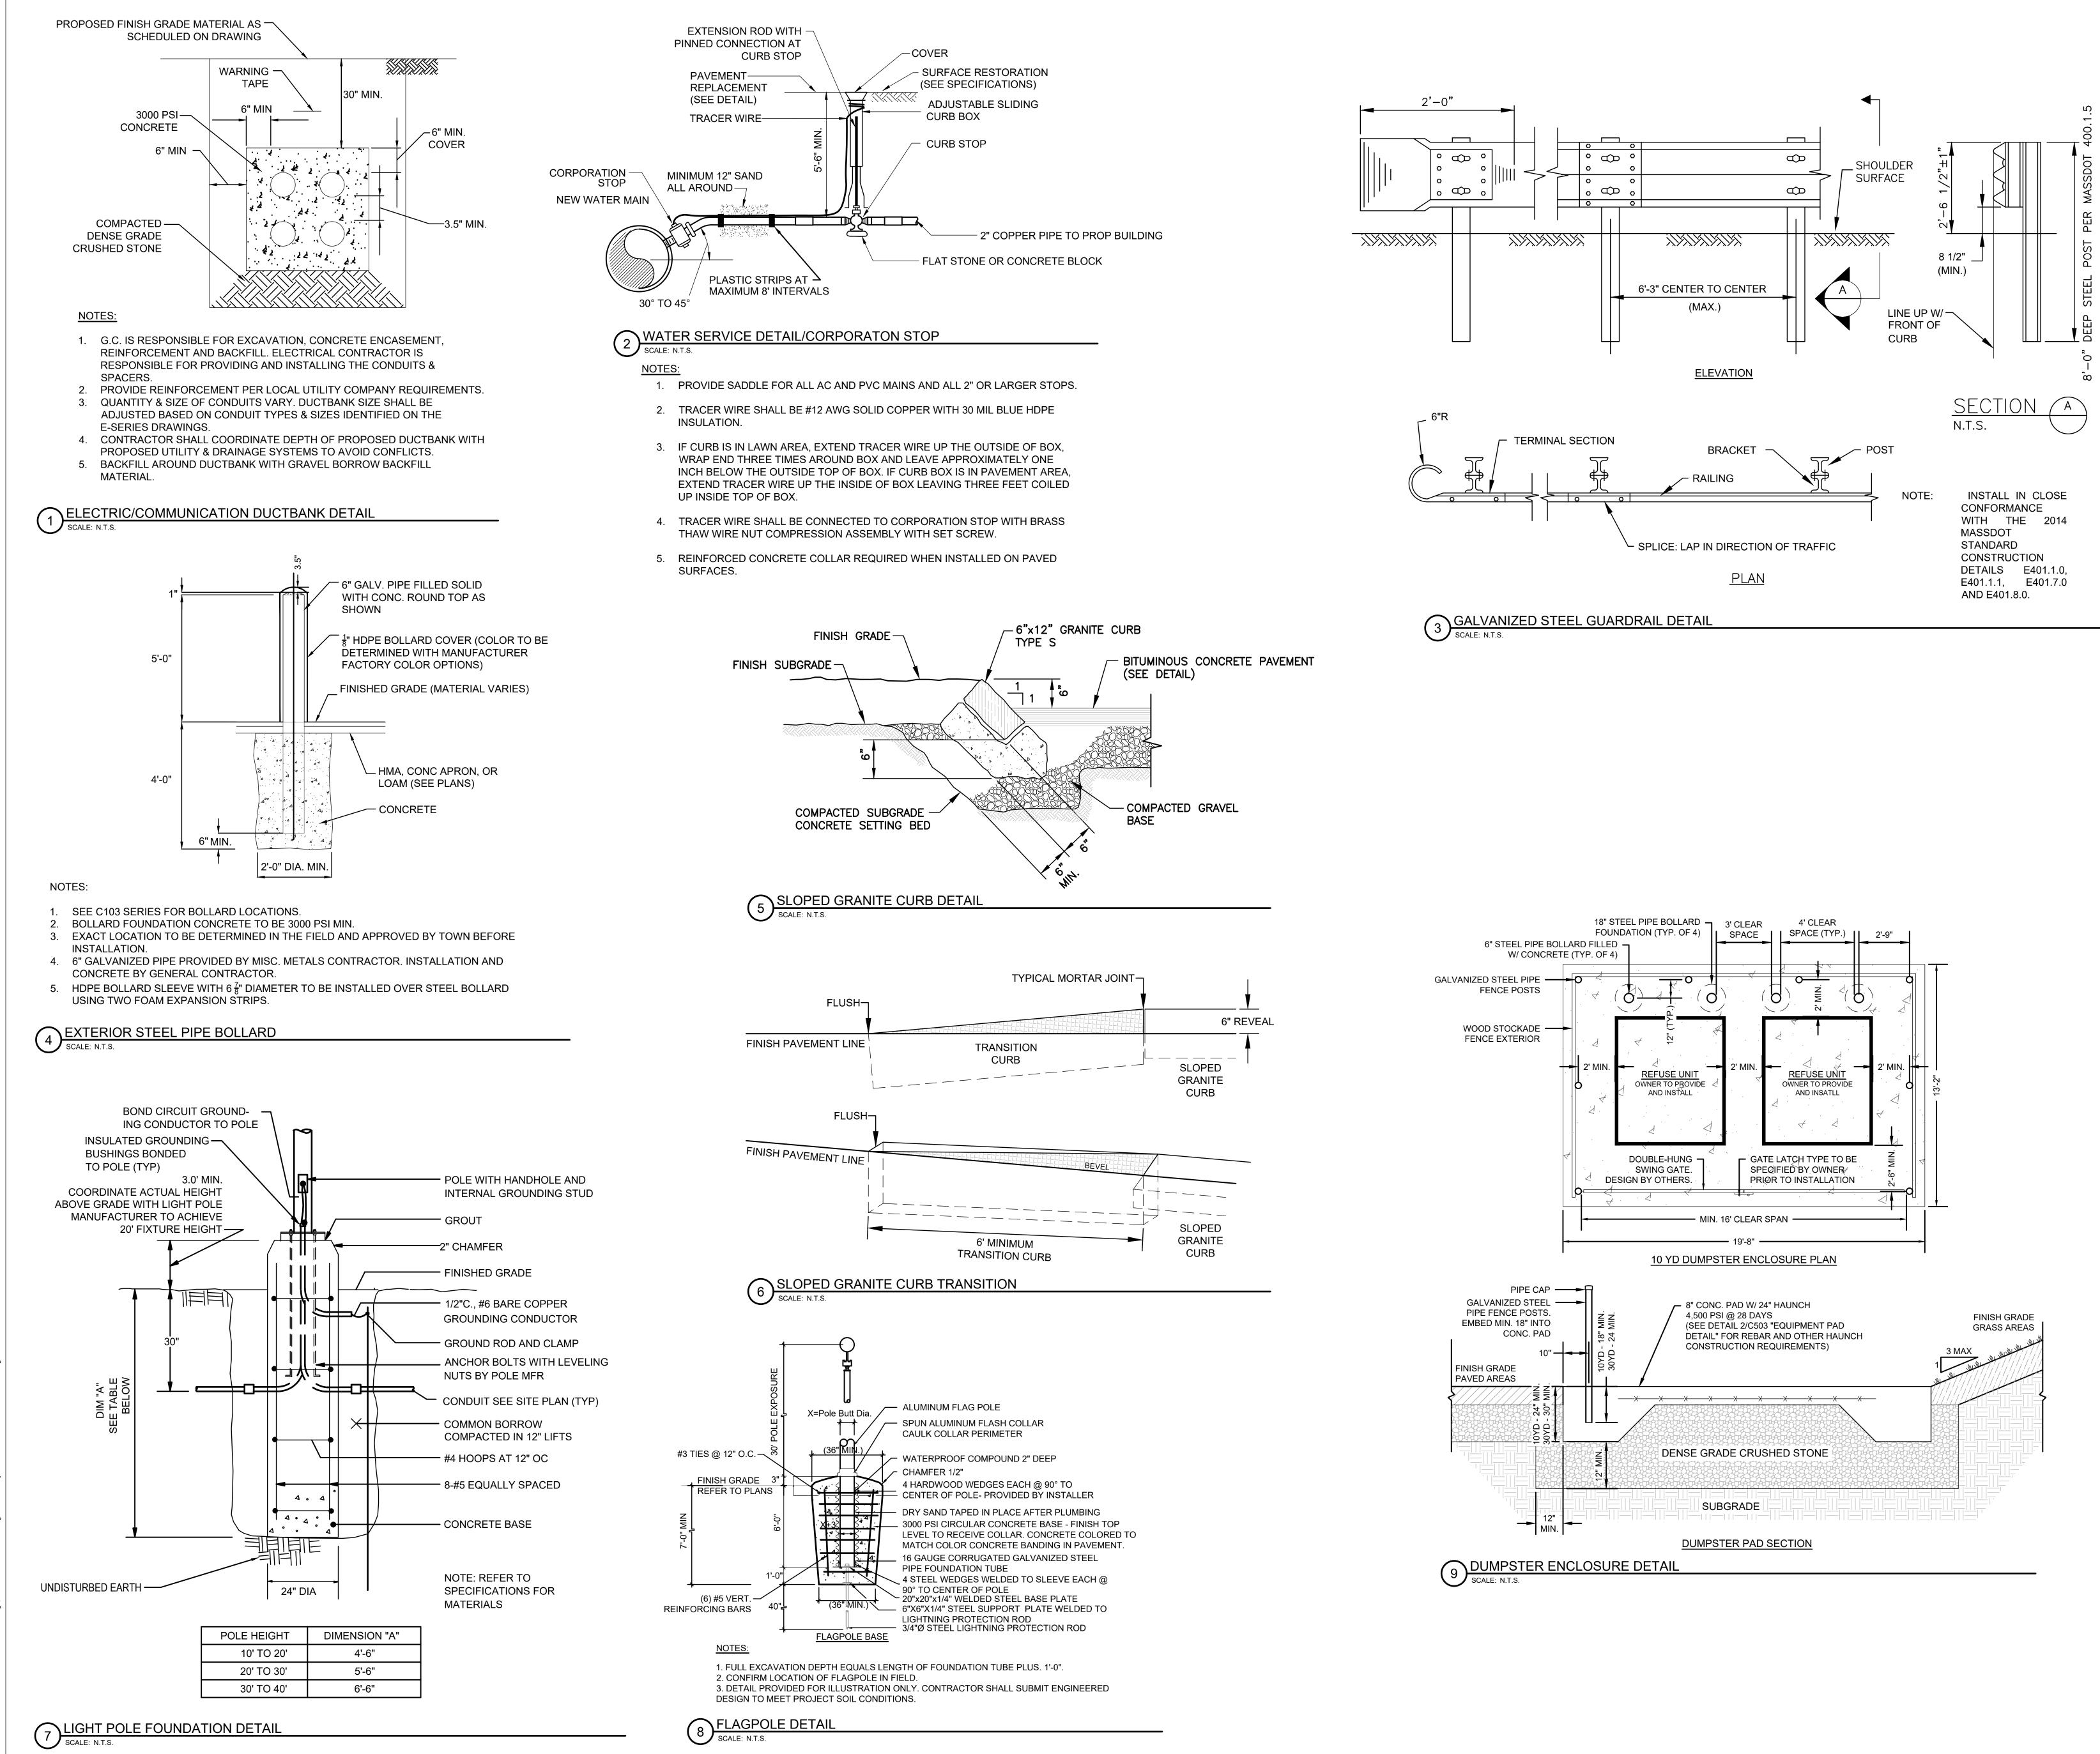
PLAN VIEW - JOINING DETAIL



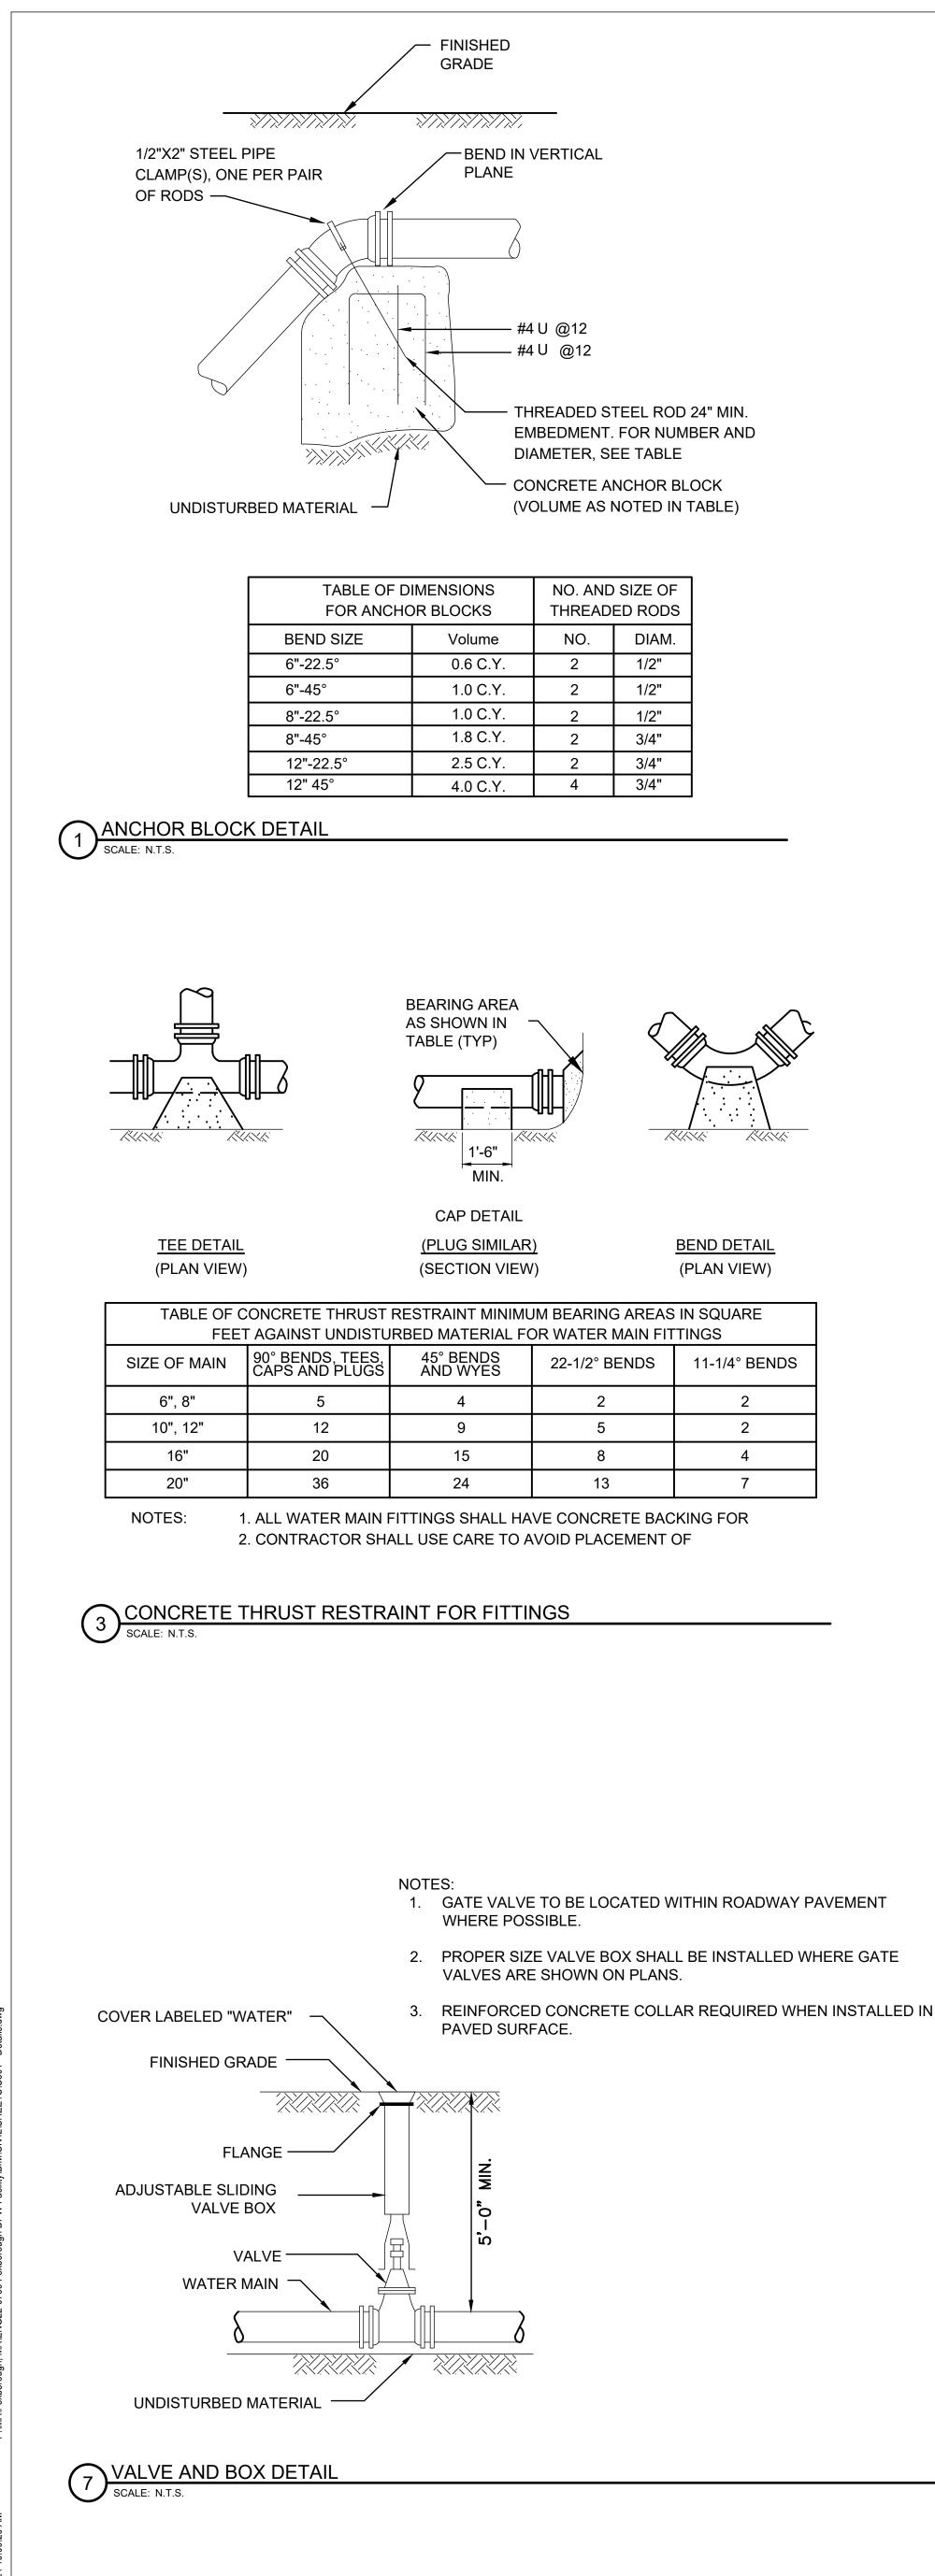
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Consultants:	
Revisions: No. Date	Description
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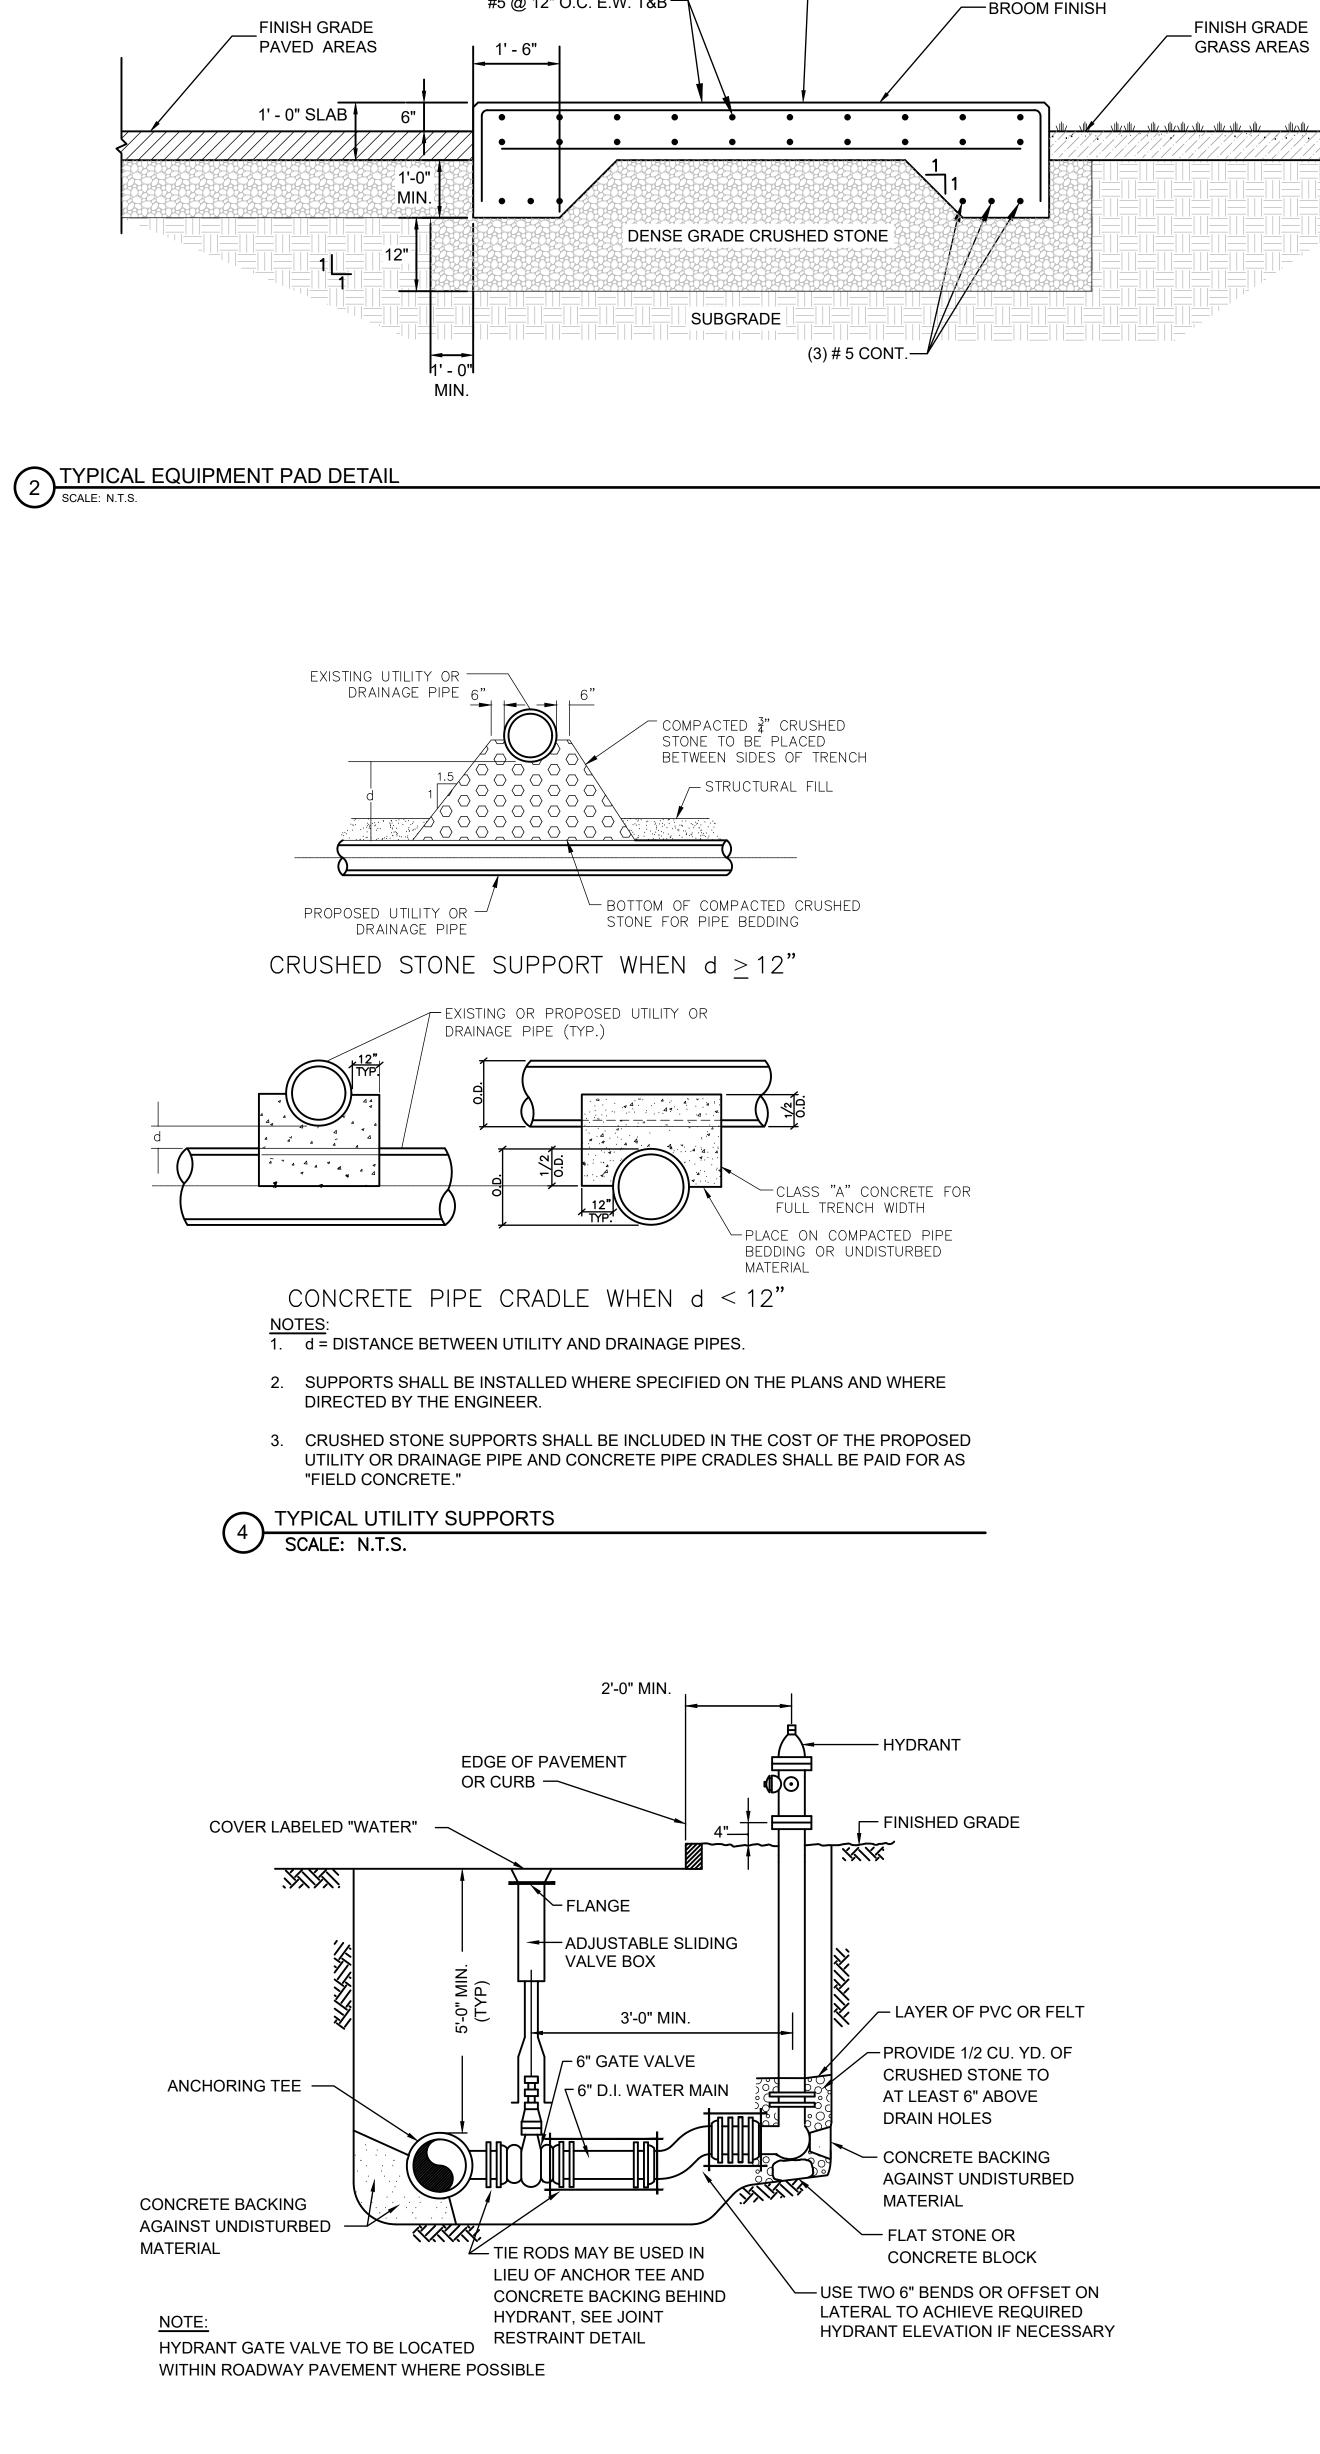


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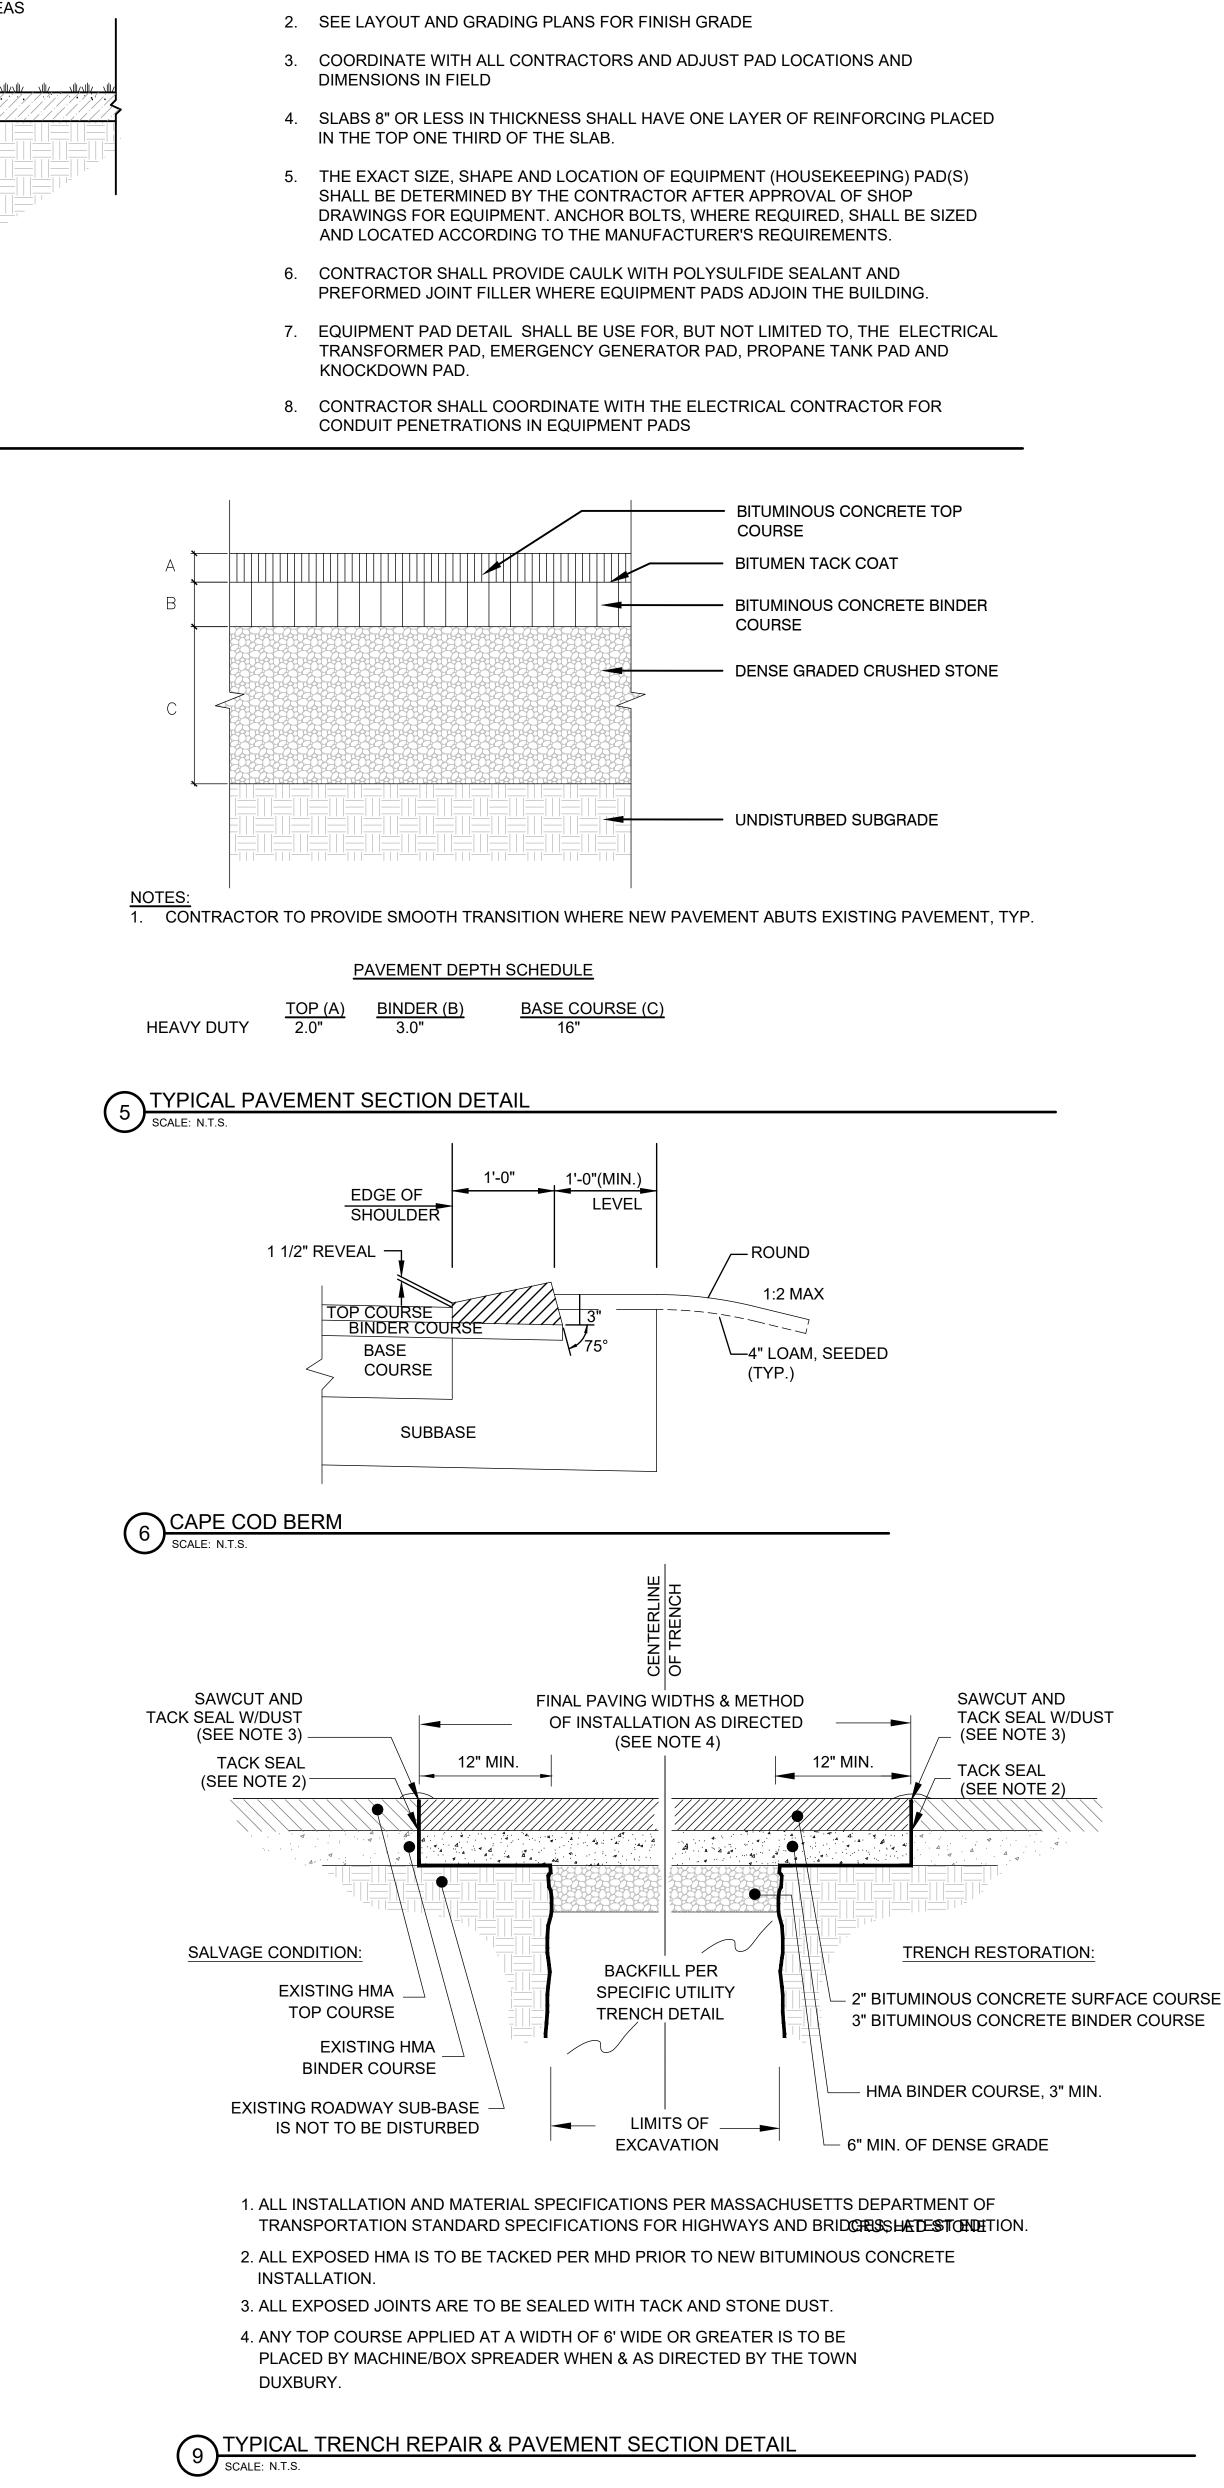


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Weston & Sam 100 Foxborough Foxborou 978.532.1900	pson Engineers, Inc. Boulevard, Suite 250 igh, MA 02035 800.SAMPSON andsampson.com					
Consultants:						
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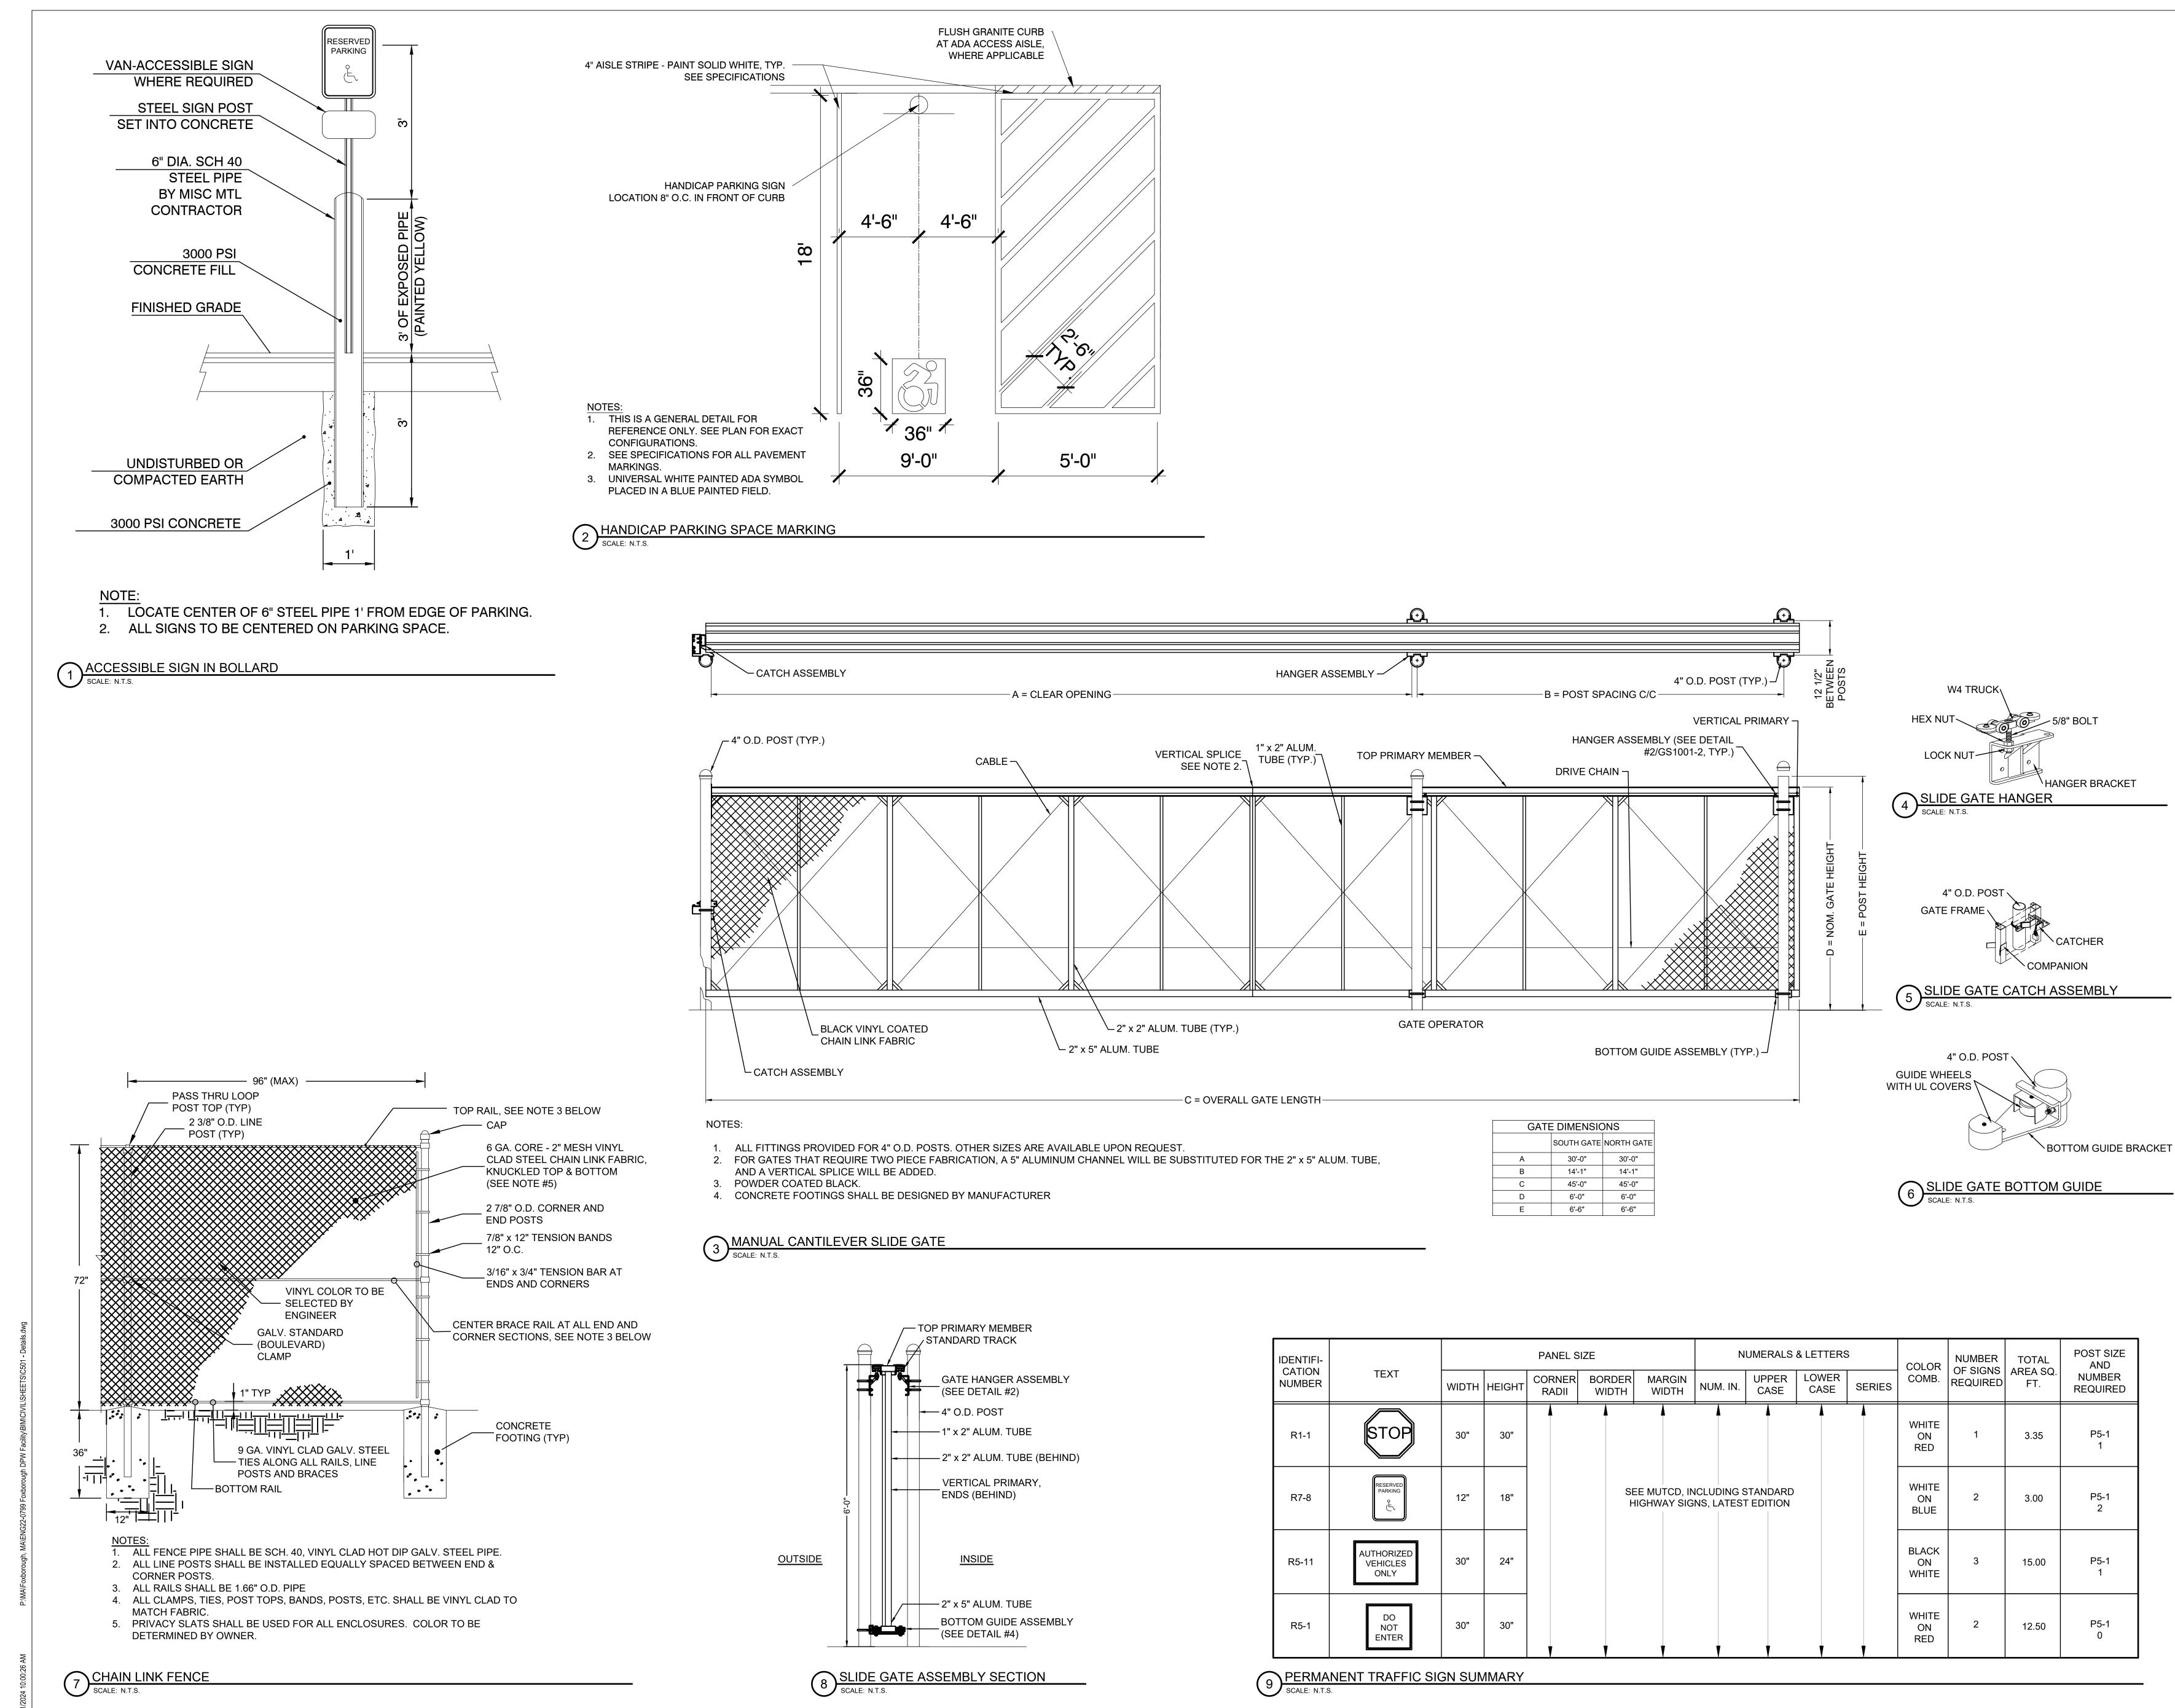
GENERAL CONTRACTOR IS RESPONSIBLE FOR CONSTRUCTION OF ALL CONCRETE

NOTES:

PADS.

TOWN OF FOXBOROUGH PUBLIC WORKS FACILITY ADDITION AND RENOVATION 70 ELM STREET FOXBOROUGH, MA 02035 Weston & Sampson Weston & Sampson Engineers, Inc. 100 Foxborough Boulevard, Suite 250 Foxborough, MA 02035 978.532.1900 800.SAMPSON www.westonandsampson.com Consultants: Revisions: No. Date Description COA: Sea 🖌 ALYSSA K PECK CIVIL No. 49074 Issued For: SITE PLAN REVIEW Scale: AS INDICATED Key Plan: FEBRUARY 1, 2024 Date RSR Drawn By EC Reviewed By: Approved By: AKP W&S Project No.: ENG22-0799 W&S File No : Drawing Title: **CIVIL DETAILS 4** Sheet Number: C504

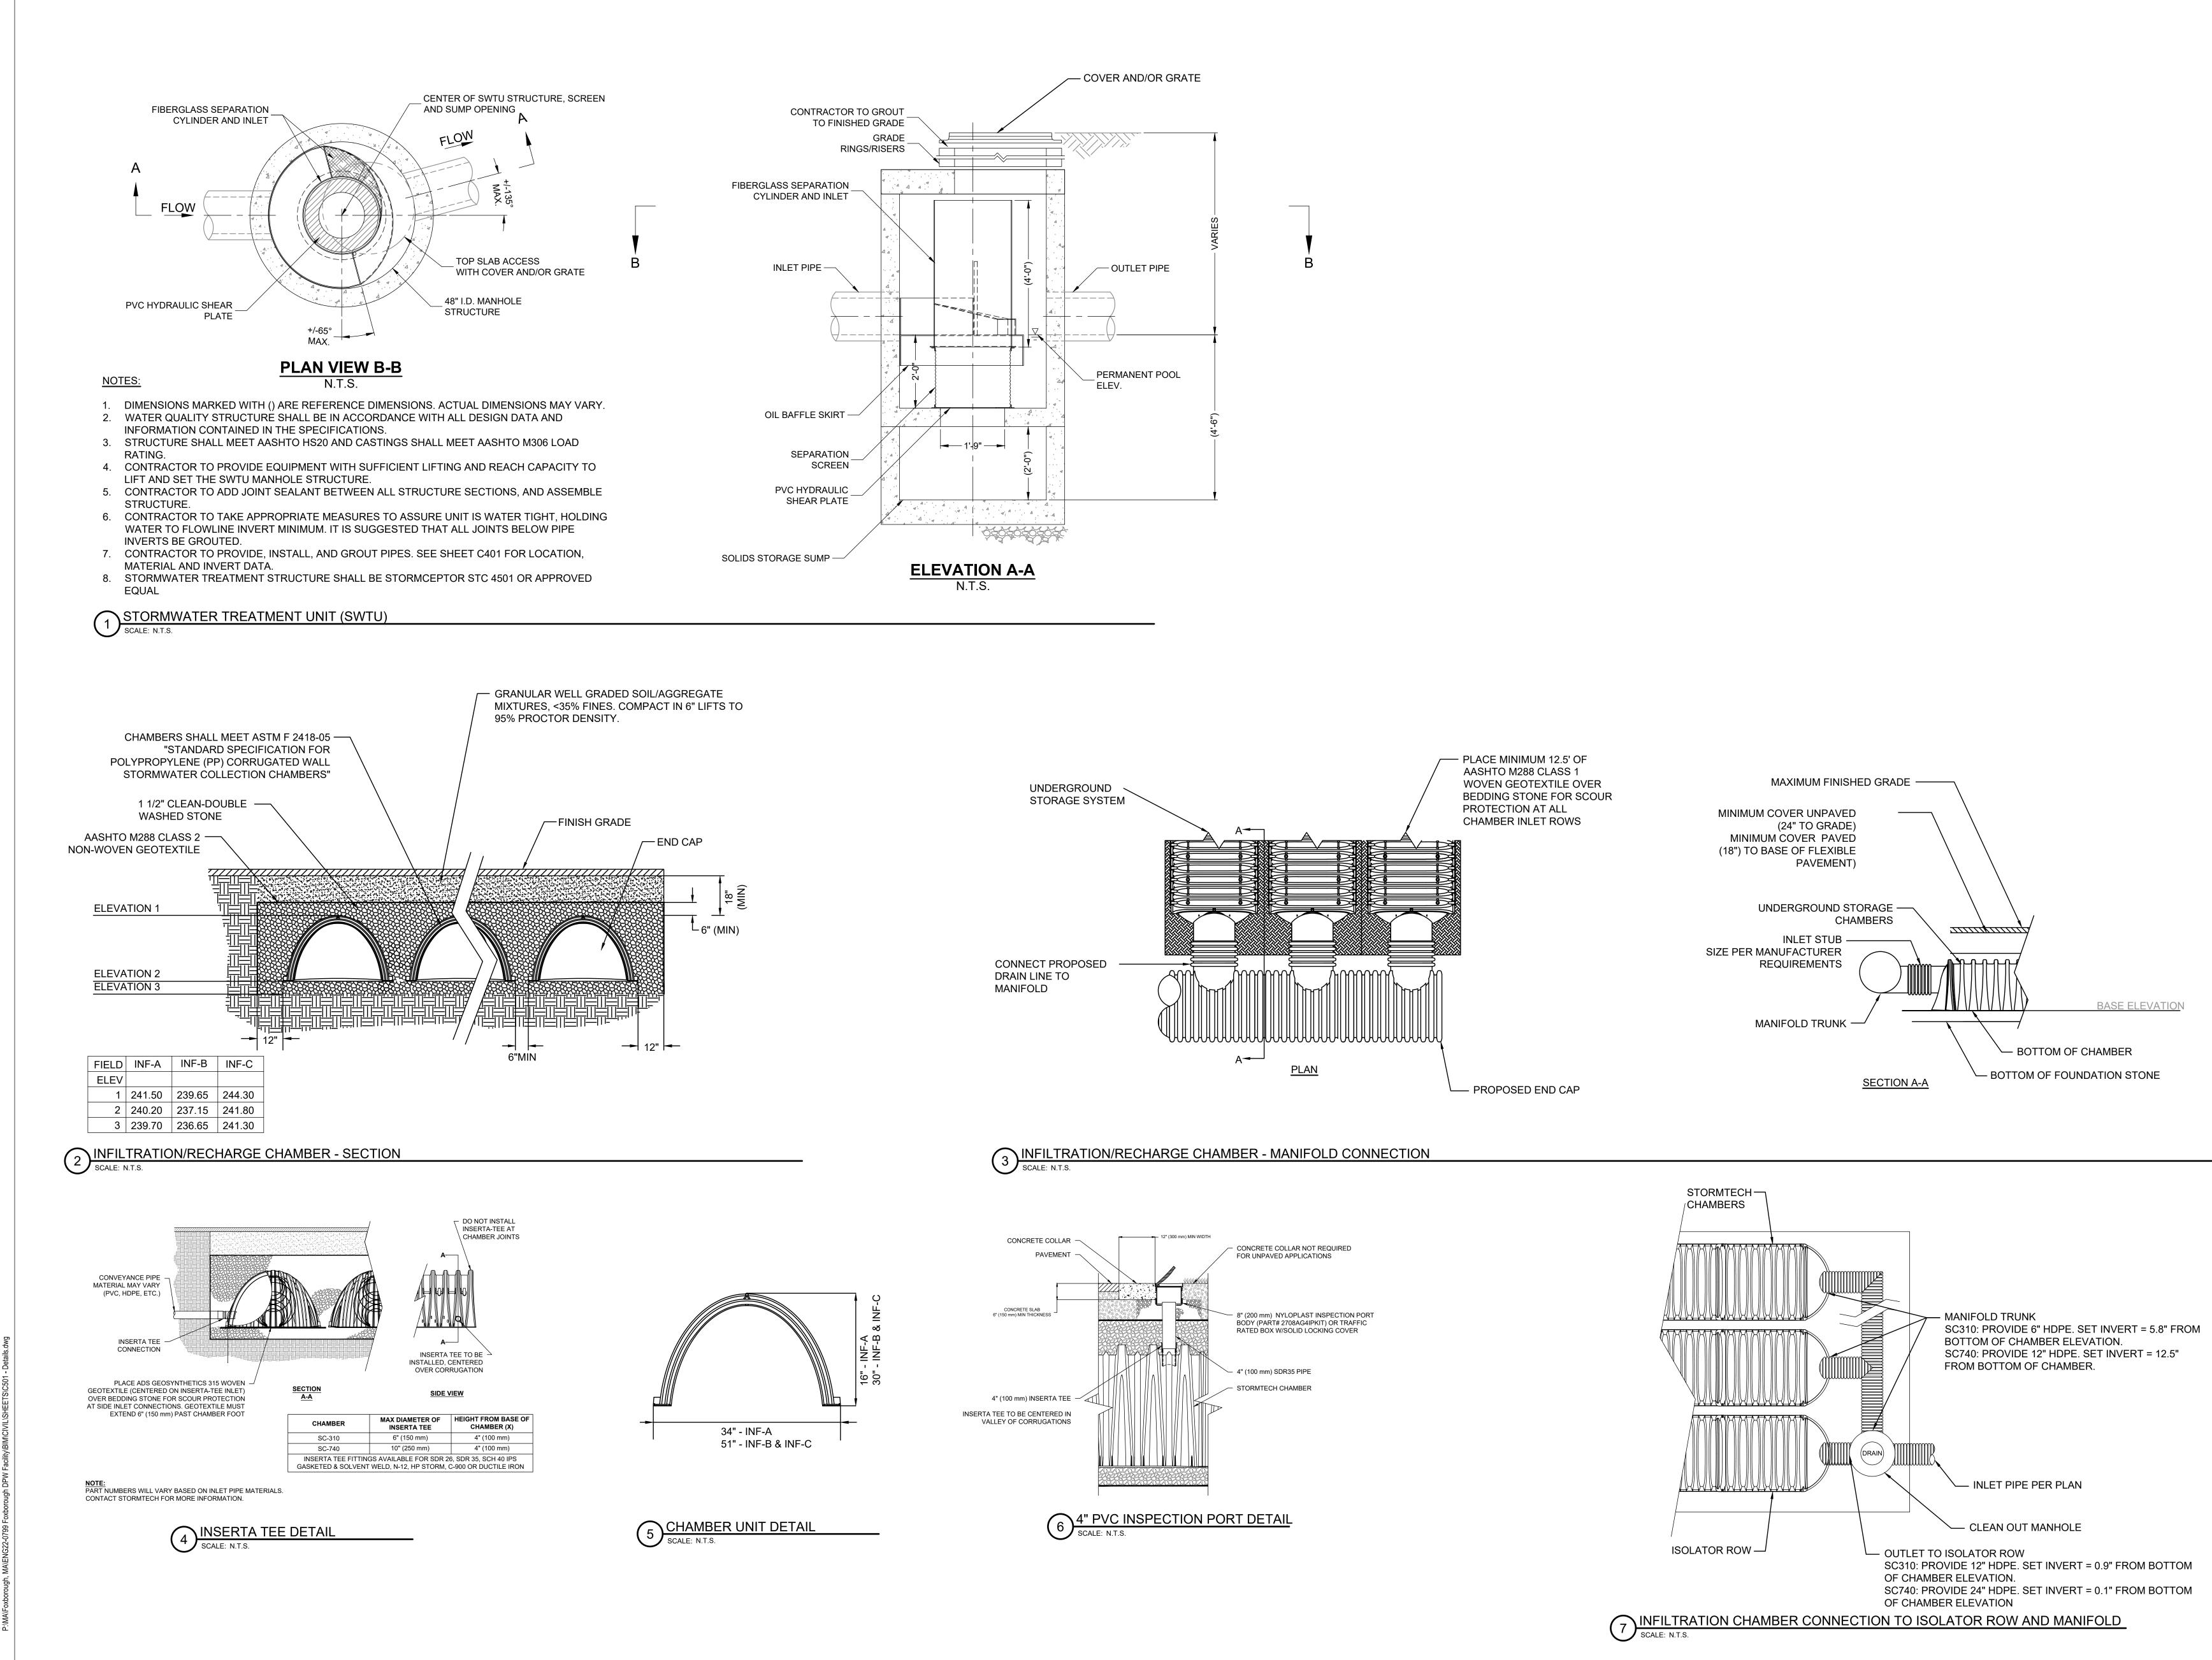
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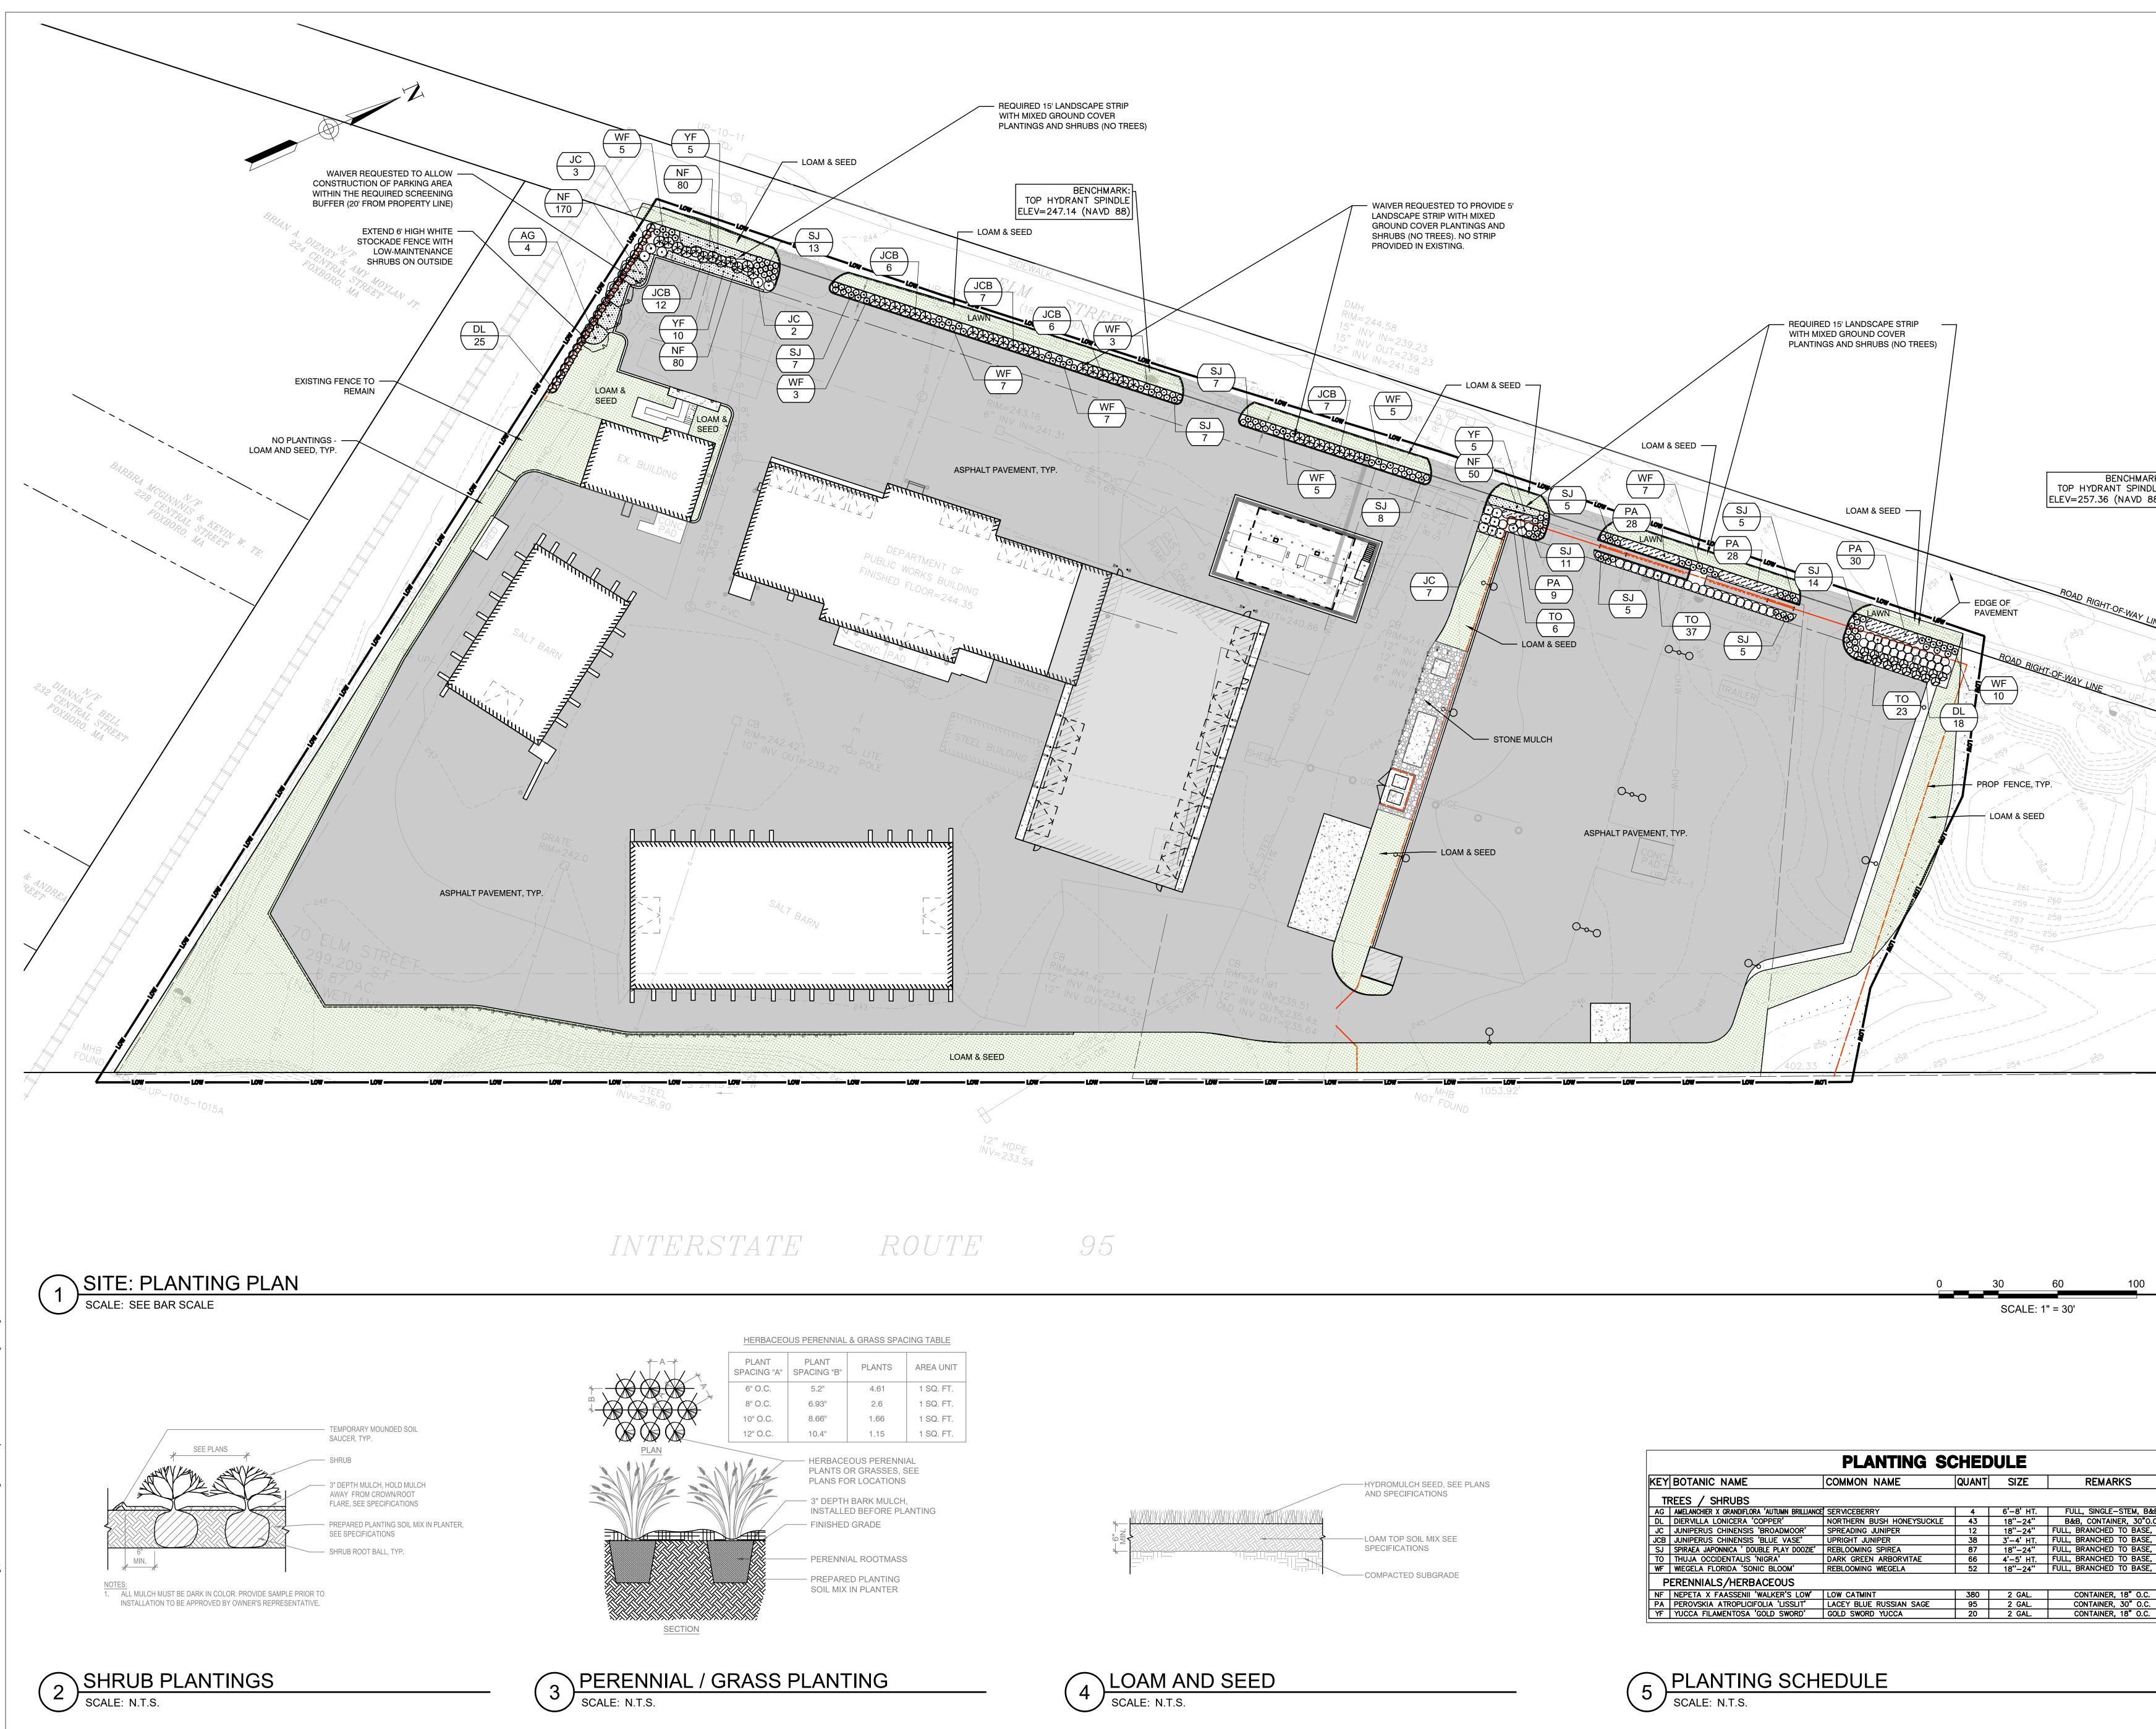
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GATE DIMENSIONS							
	SOUTH GATE	NORTH GATE					
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В	14'-1"	14'-1"					
С	45'-0"	45'-0"					
D	6'-0"	6'-0"					
E	6'-6"	6'-6"					
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Project: TOWN OF FOXBOROUGH PUBLIC WORKS FACILITY
ADDITION AND RENOVATION
70 ELM STREET FOXBOROUGH, MA 02035
Weston & Sampson Engineers, Inc. 100 Foxborough Boulevard, Suite 250 Foxborough, MA 02035 978.532.1900 800.SAMPSON www.westonandsampson.com
Consultants:
Revisions:   No. Date     Description
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Seal: ALYSSA K. PECK CIVIL No. 49074
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Date:FEBRUARY 1, 2024Drawn By:RSRReviewed By:ECApproved By:AKPW&S Project No.:ENG22-0799W&S File No.:
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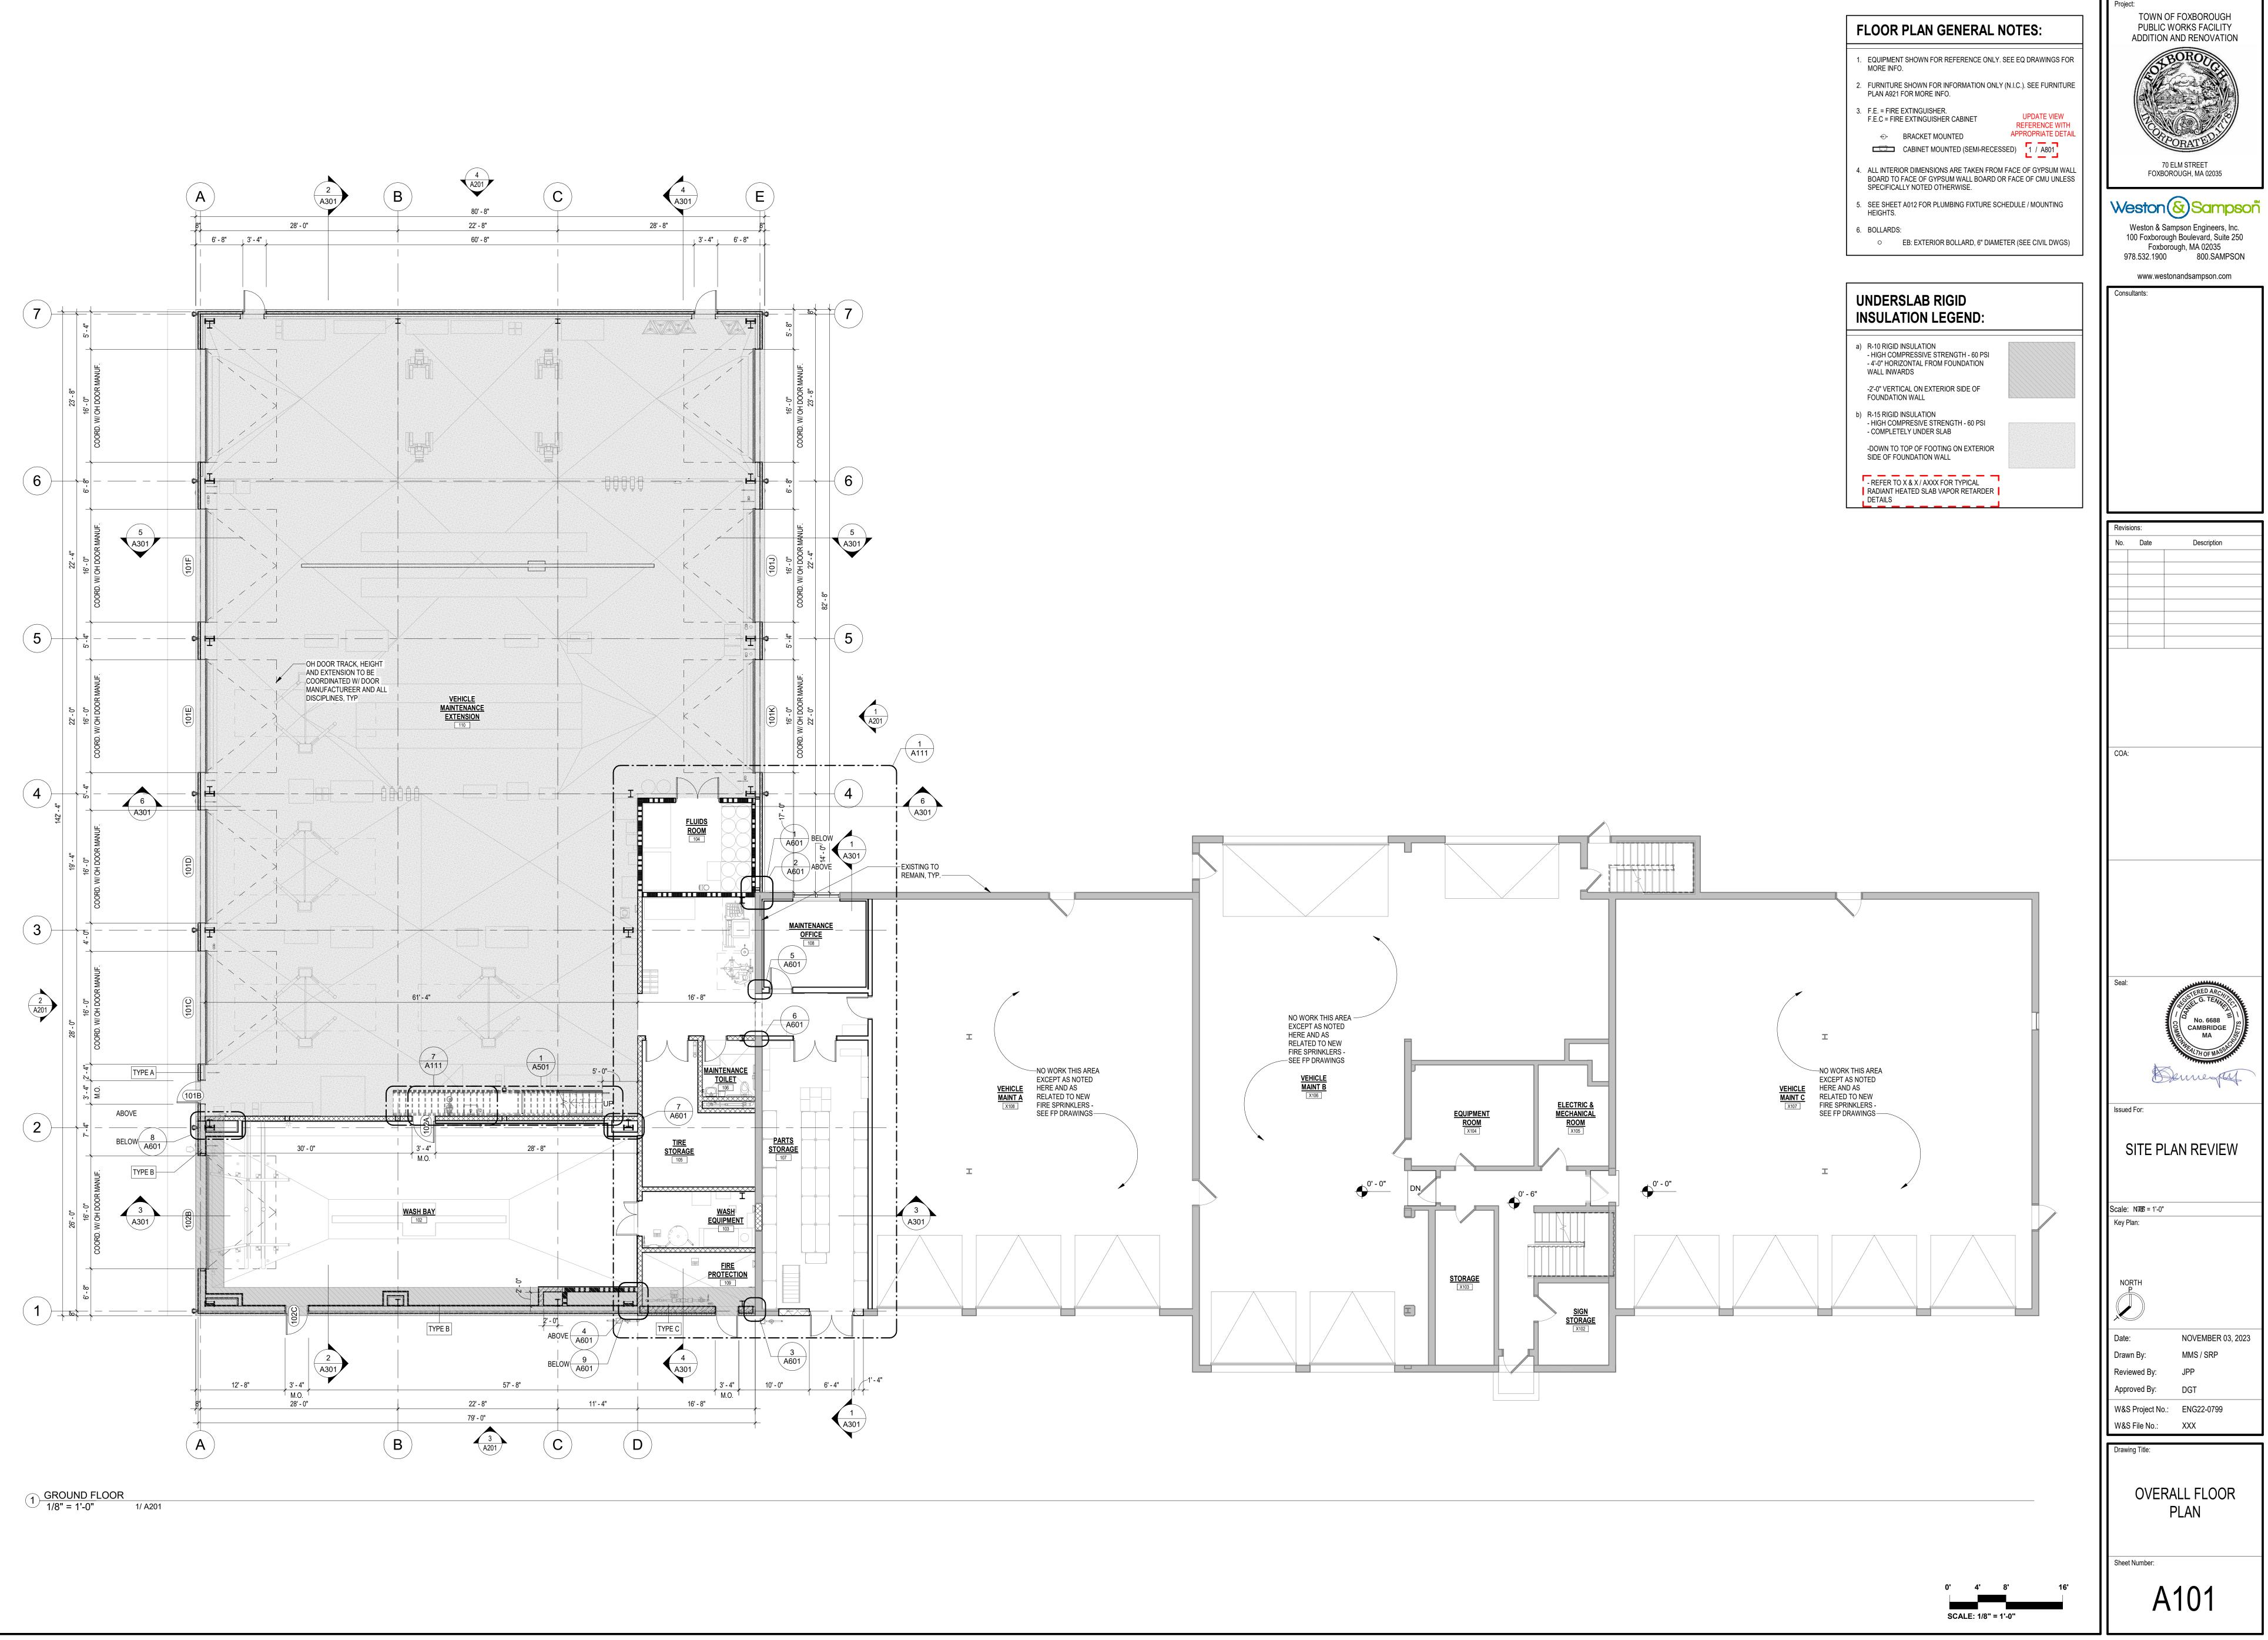
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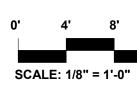


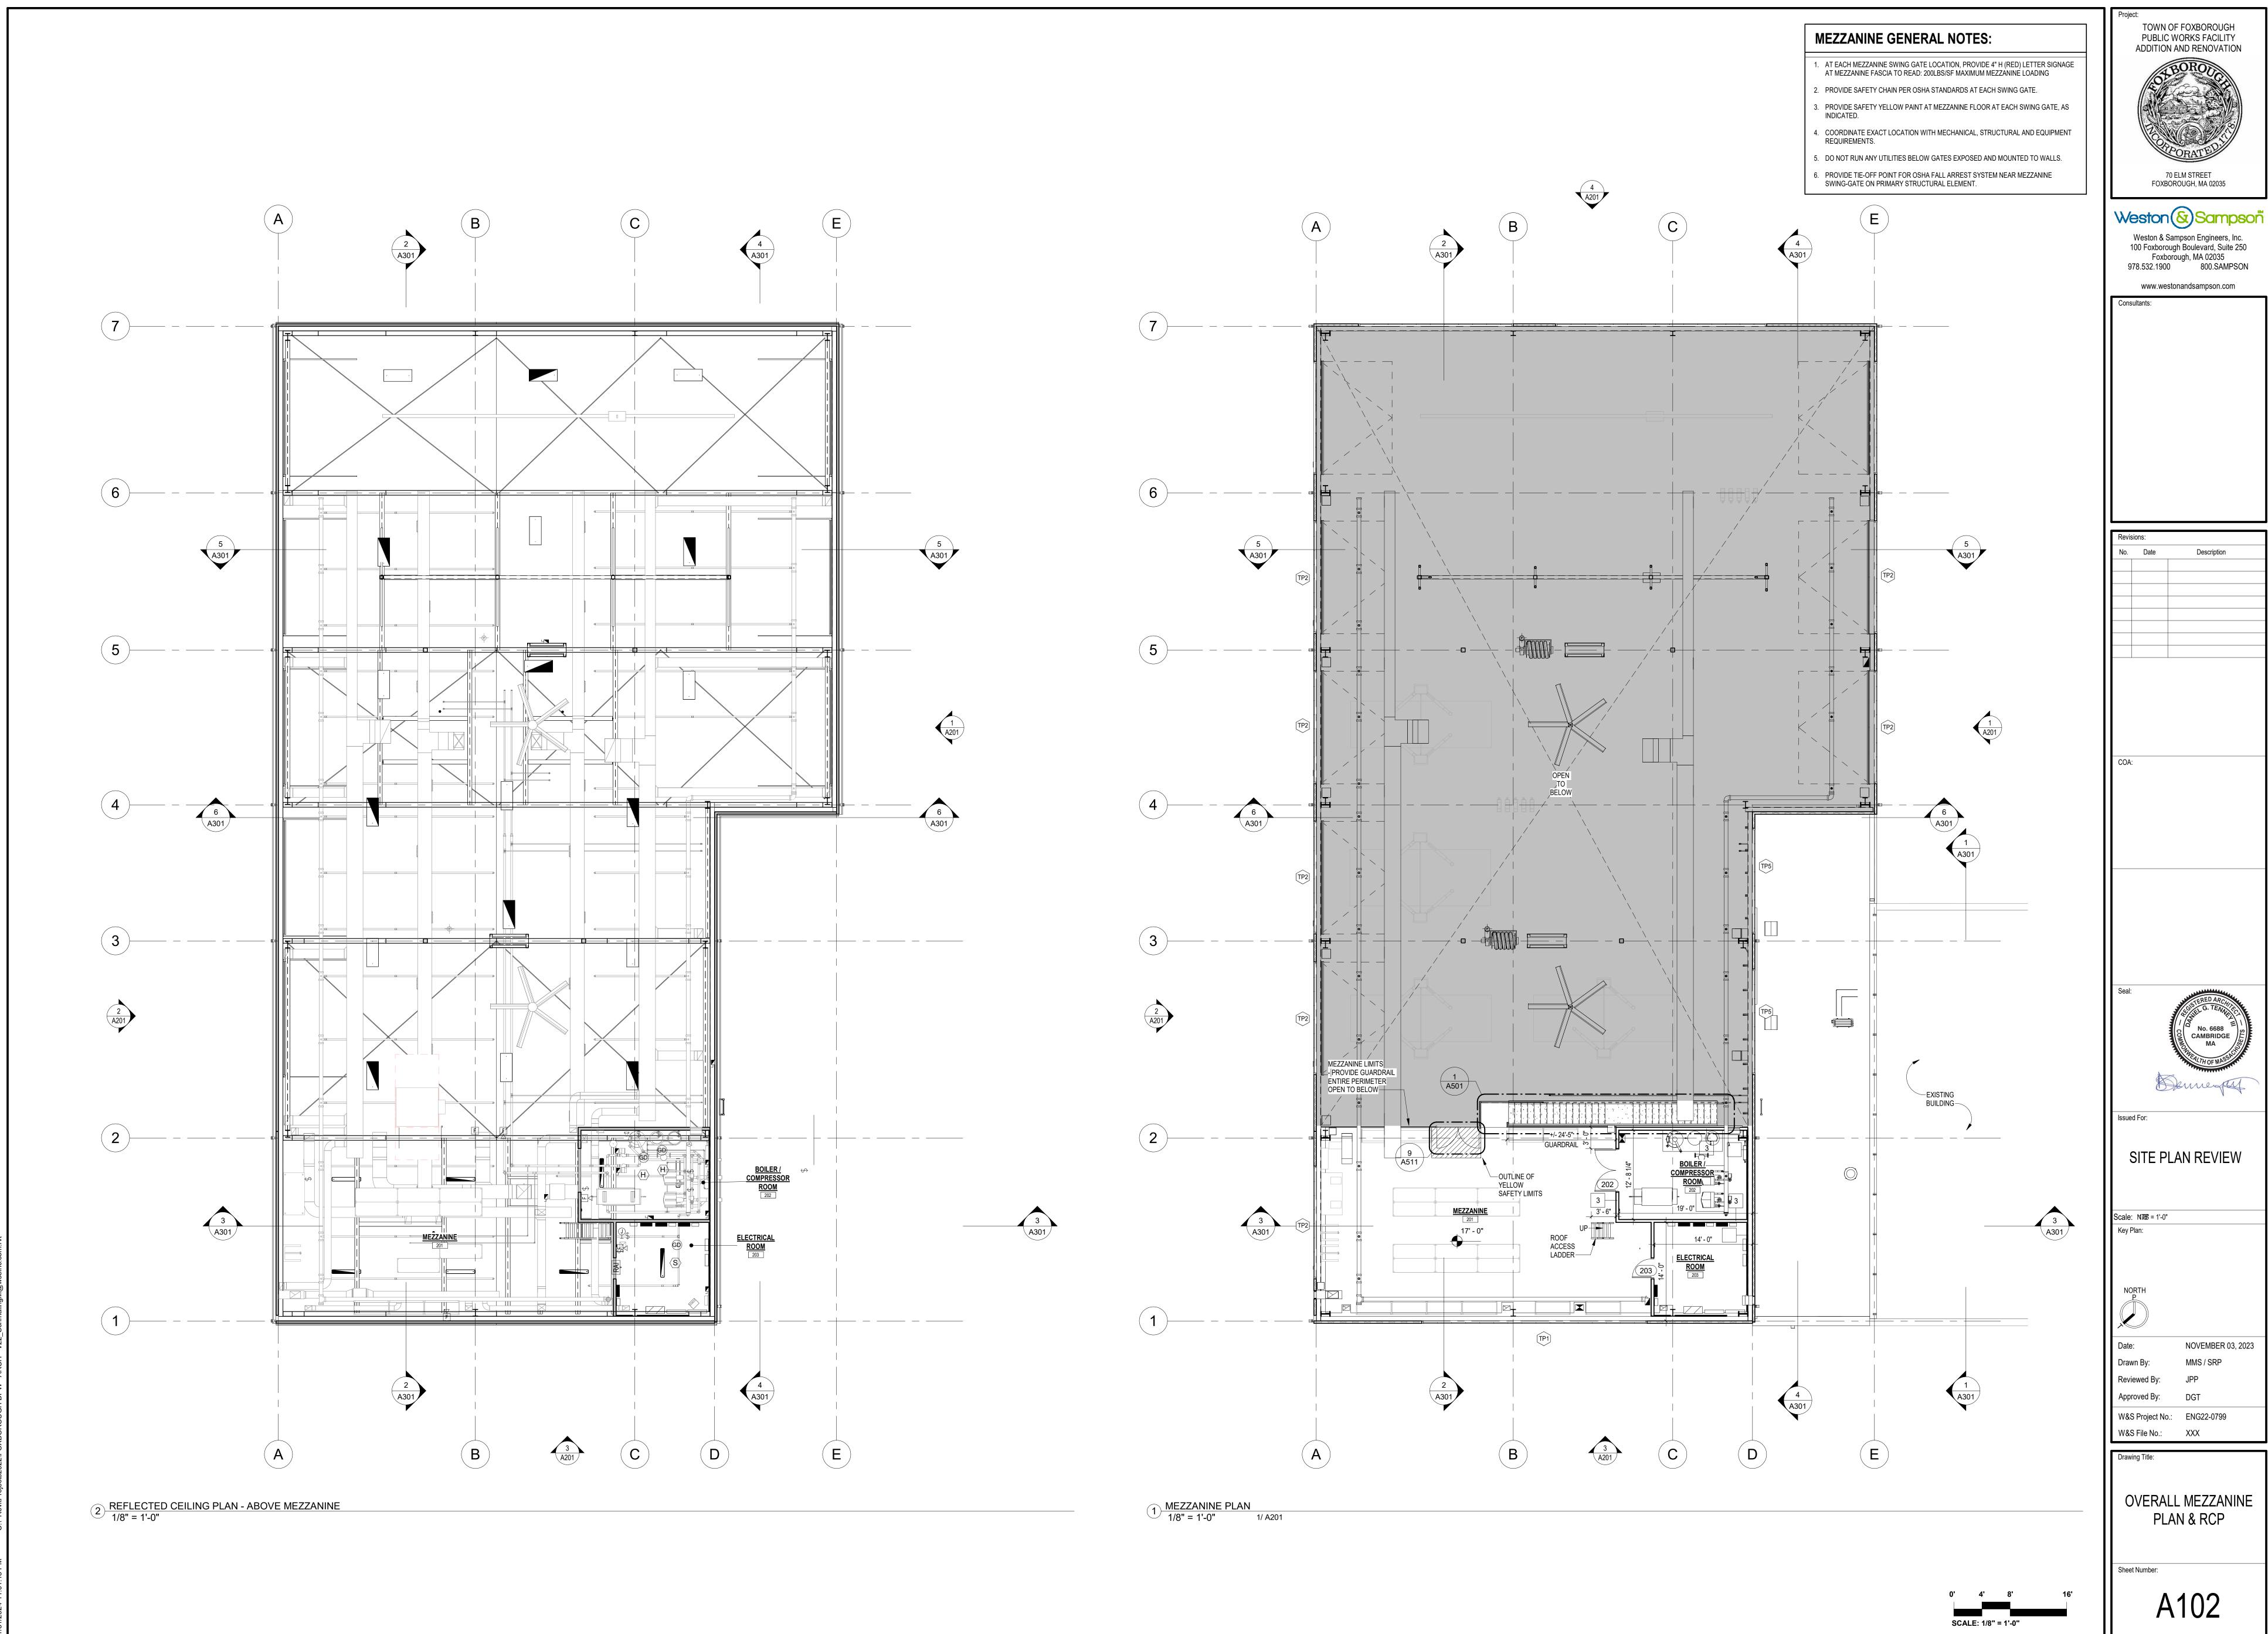
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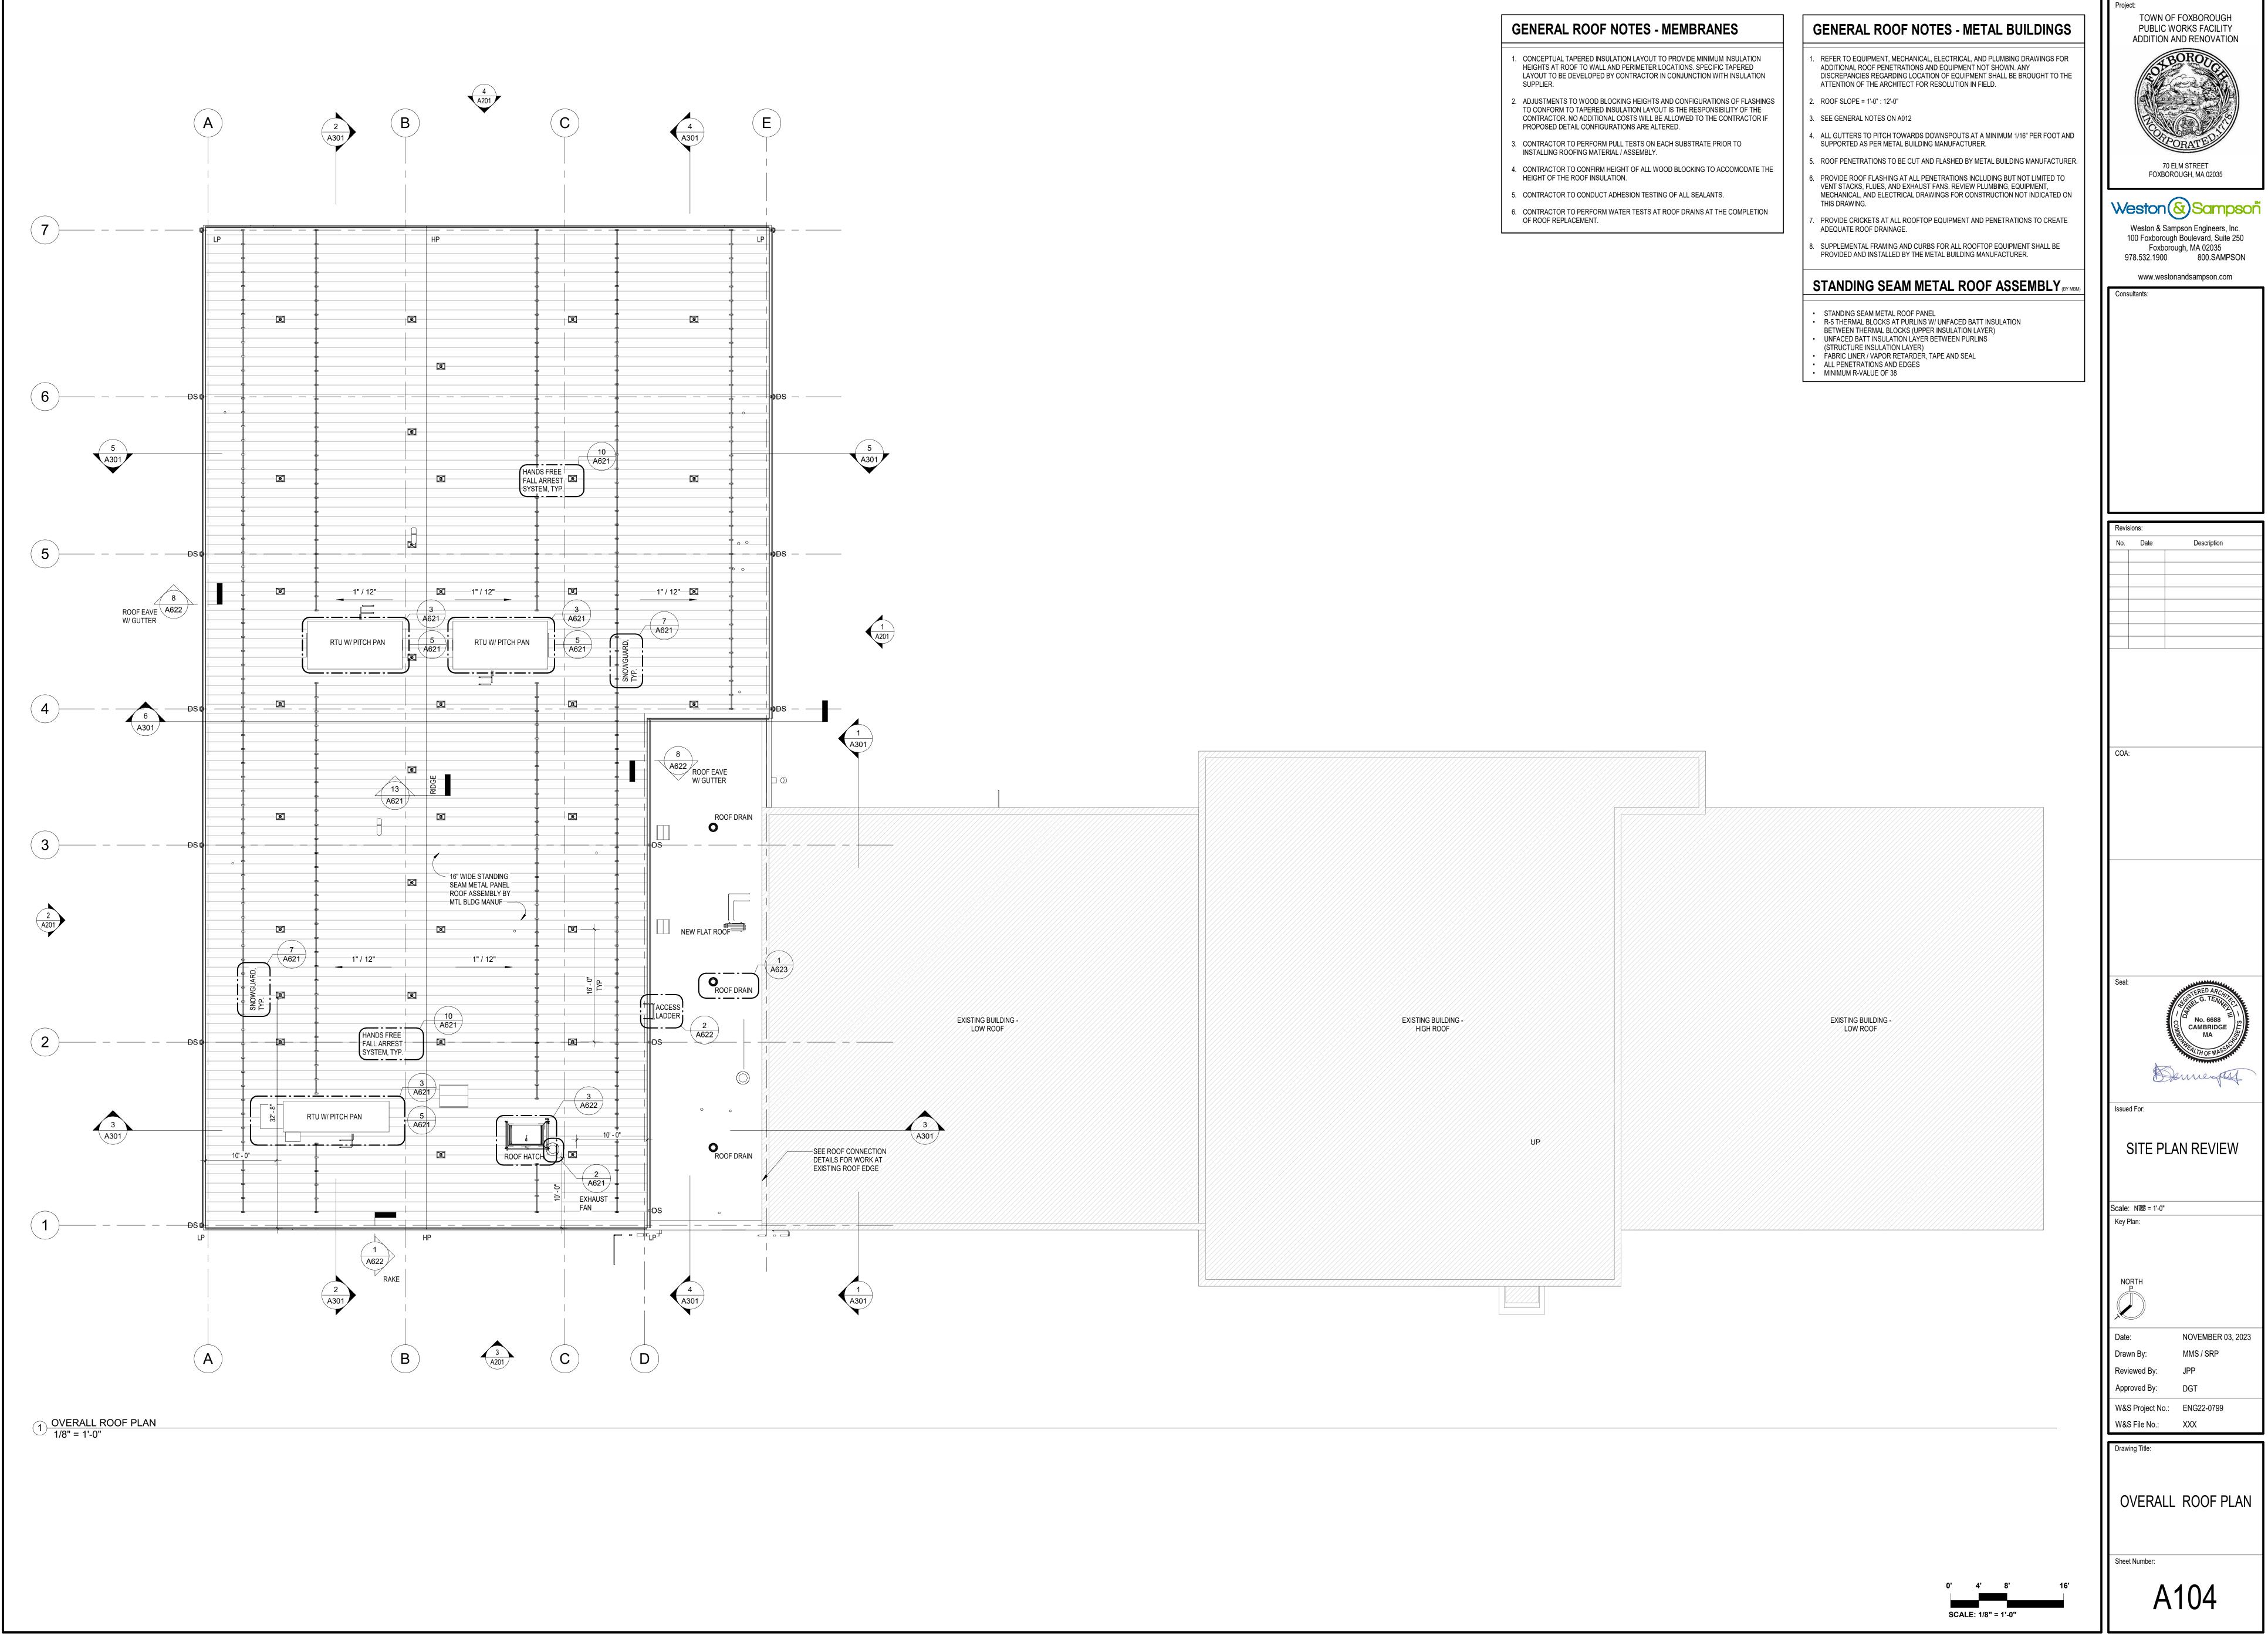
		PLANTING S	CHED	ULE	
KEY	BOTANIC NAME	COMMON NAME	QUANT	SIZE	REMARKS
TF	REES / SHRUBS				
AG	AMELANCHIER X GRANDIFLORA 'AUTUMN BRILLIANCE	SERVICEBERRY	4	6'-8' HT.	FULL, SINGLE-STEM, E
DL	DIERVILLA LONICERA 'COPPER'	NORTHERN BUSH HONEYSUCKLE	43	18"-24"	B&B, CONTAINER, 30"
JC	JUNIPERUS CHINENSIS 'BROADMOOR'	SPREADING JUNIPER	12	18"-24"	FULL, BRANCHED TO BASI
JCB	JUNIPERUS CHINENSIS 'BLUE VASE'	UPRIGHT JUNIPER	38	3'-4' HT.	FULL, BRANCHED TO BASI
SJ	SPIRAEA JAPONNICA ' DOUBLE PLAY DOOZIE'	REBLOOMING SPIREA	87	18"-24"	FULL, BRANCHED TO BASE
TO	THUJA OCCIDENTALIS 'NIGRA'	DARK GREEN ARBORVITAE	66	4'–5' HT.	FULL, BRANCHED TO BASE
WF	WIEGELA FLORIDA 'SONIC BLOOM'	REBLOOMING WIEGELA	52	18"-24"	FULL, BRANCHED TO BASE
Ρ	ERENNIALS/HERBACEOUS				
NF	NEPETA X FAASSENII 'WALKER'S LOW'	LOW CATMINT	380	2 GAL.	CONTAINER, 18" O.C
PA	PEROVSKIA ATROPLICIFOLIA 'LISSLIT'	LACEY BLUE RUSSIAN SAGE	95	2 GAL.	CONTAINER, 30" O.C
YF	YUCCA FILAMENTOSA 'GOLD SWORD'	GOLD SWORD YUCCA	20	2 GAL.	CONTAINER, 18" O.C

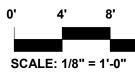
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	FOXBOROUGH, MA 02035
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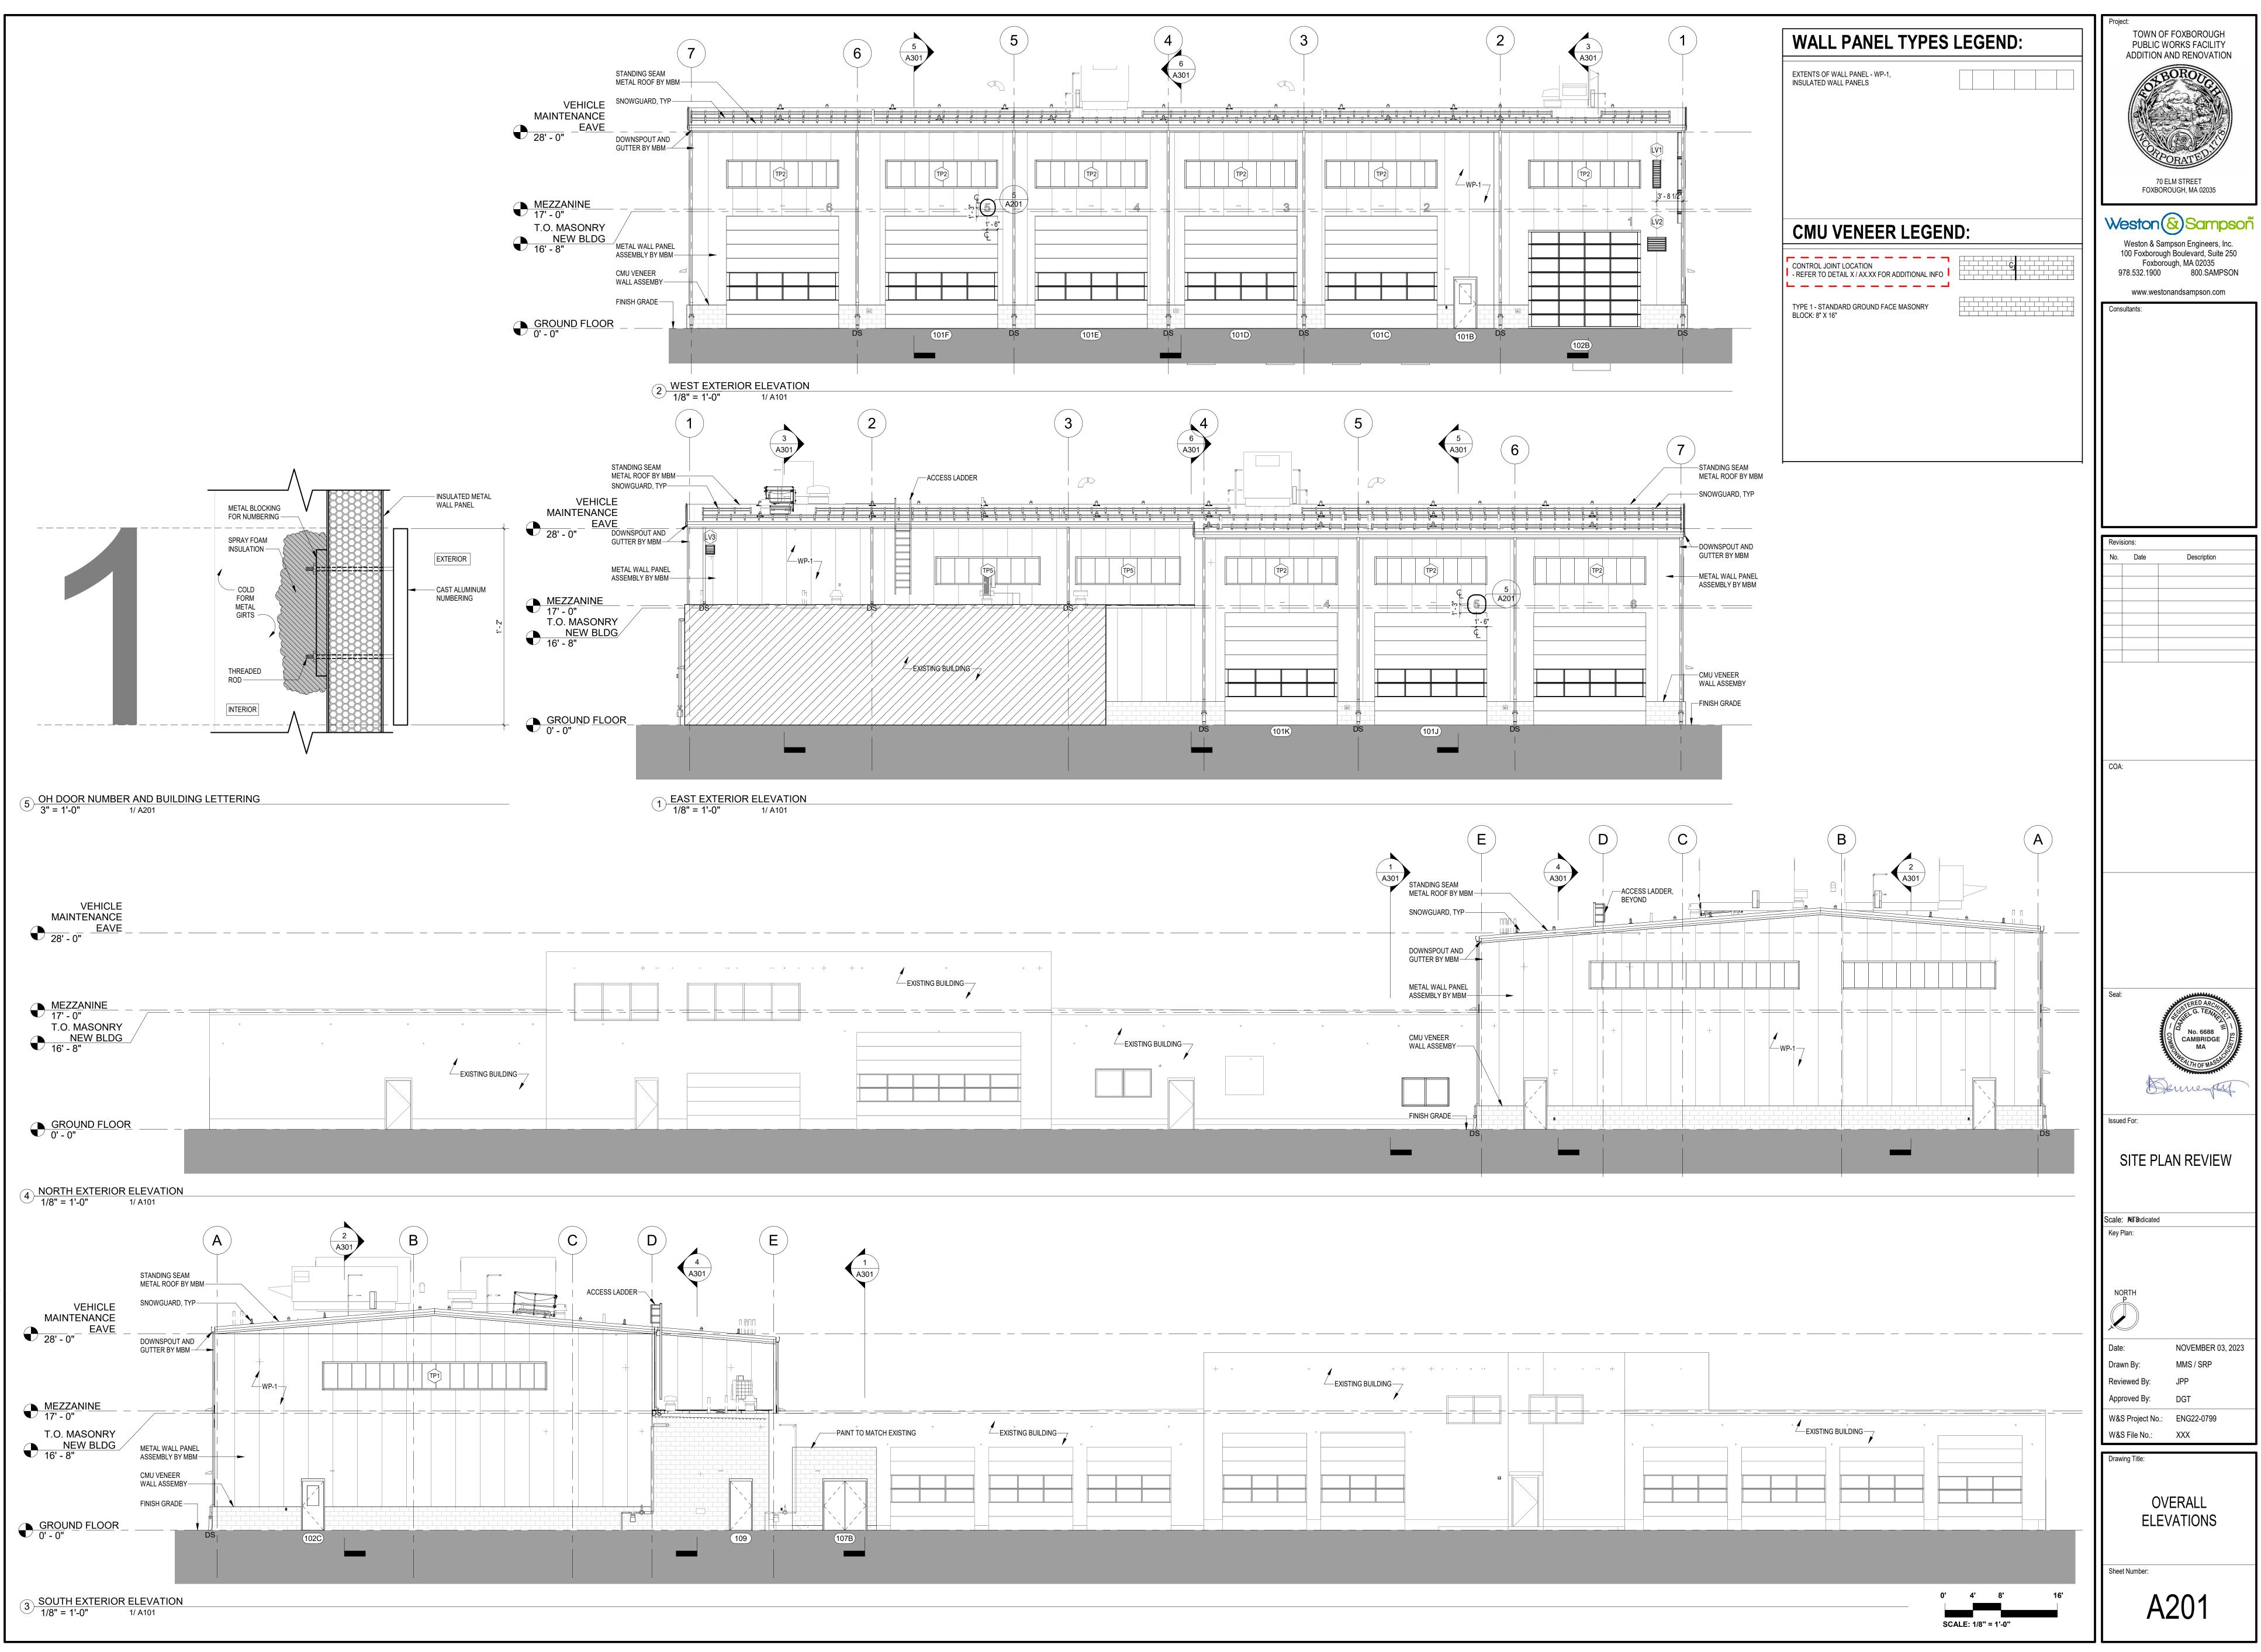






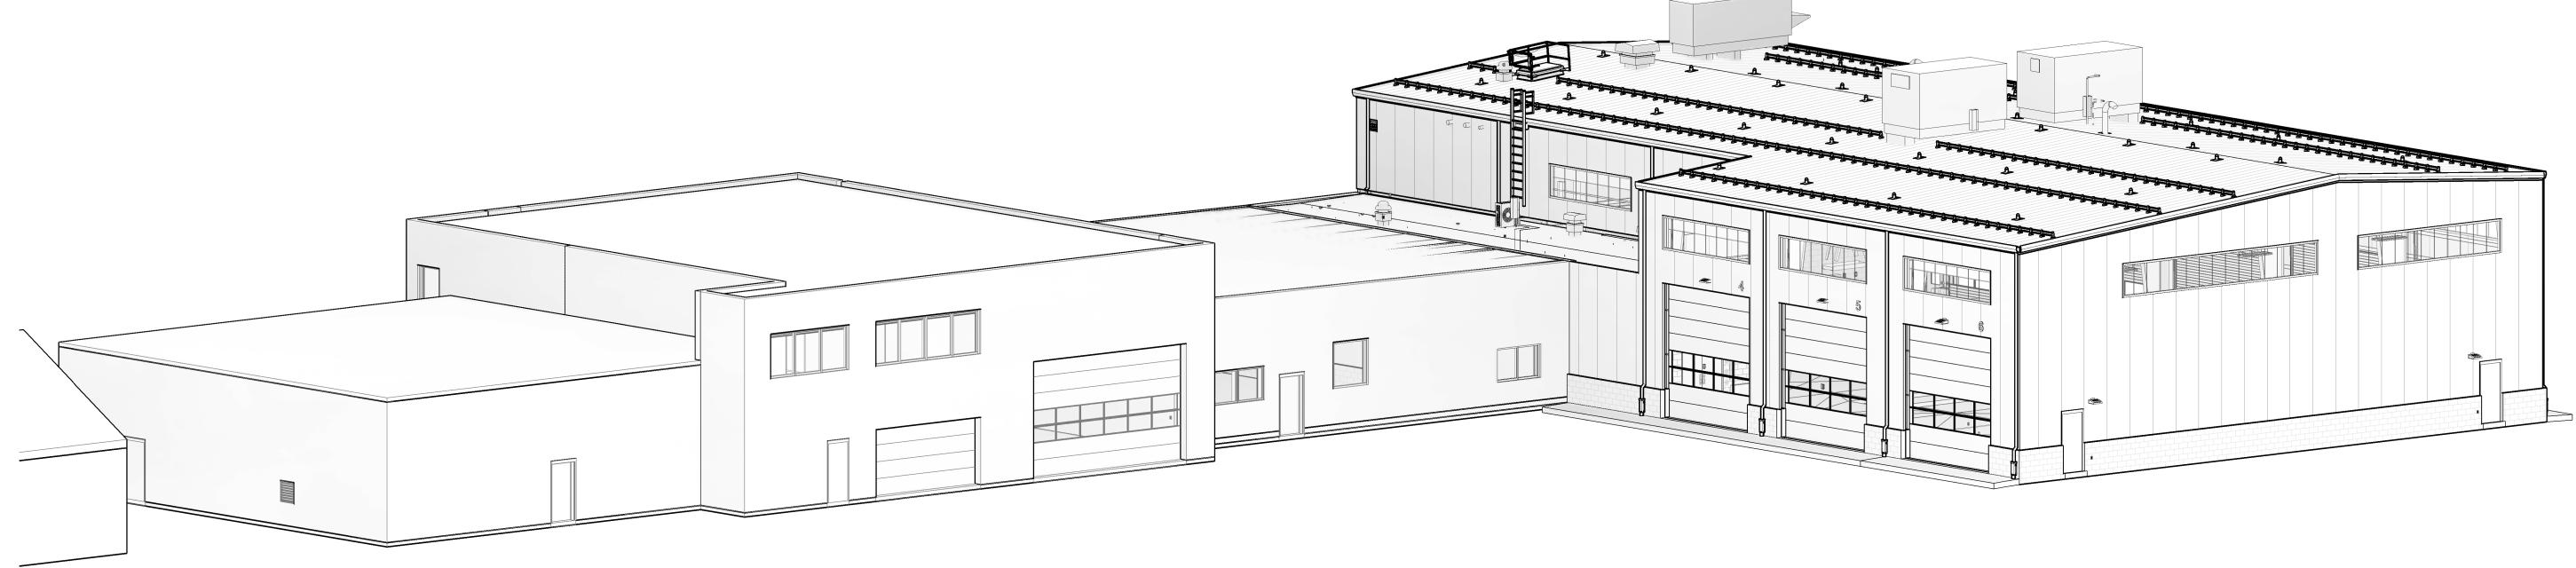




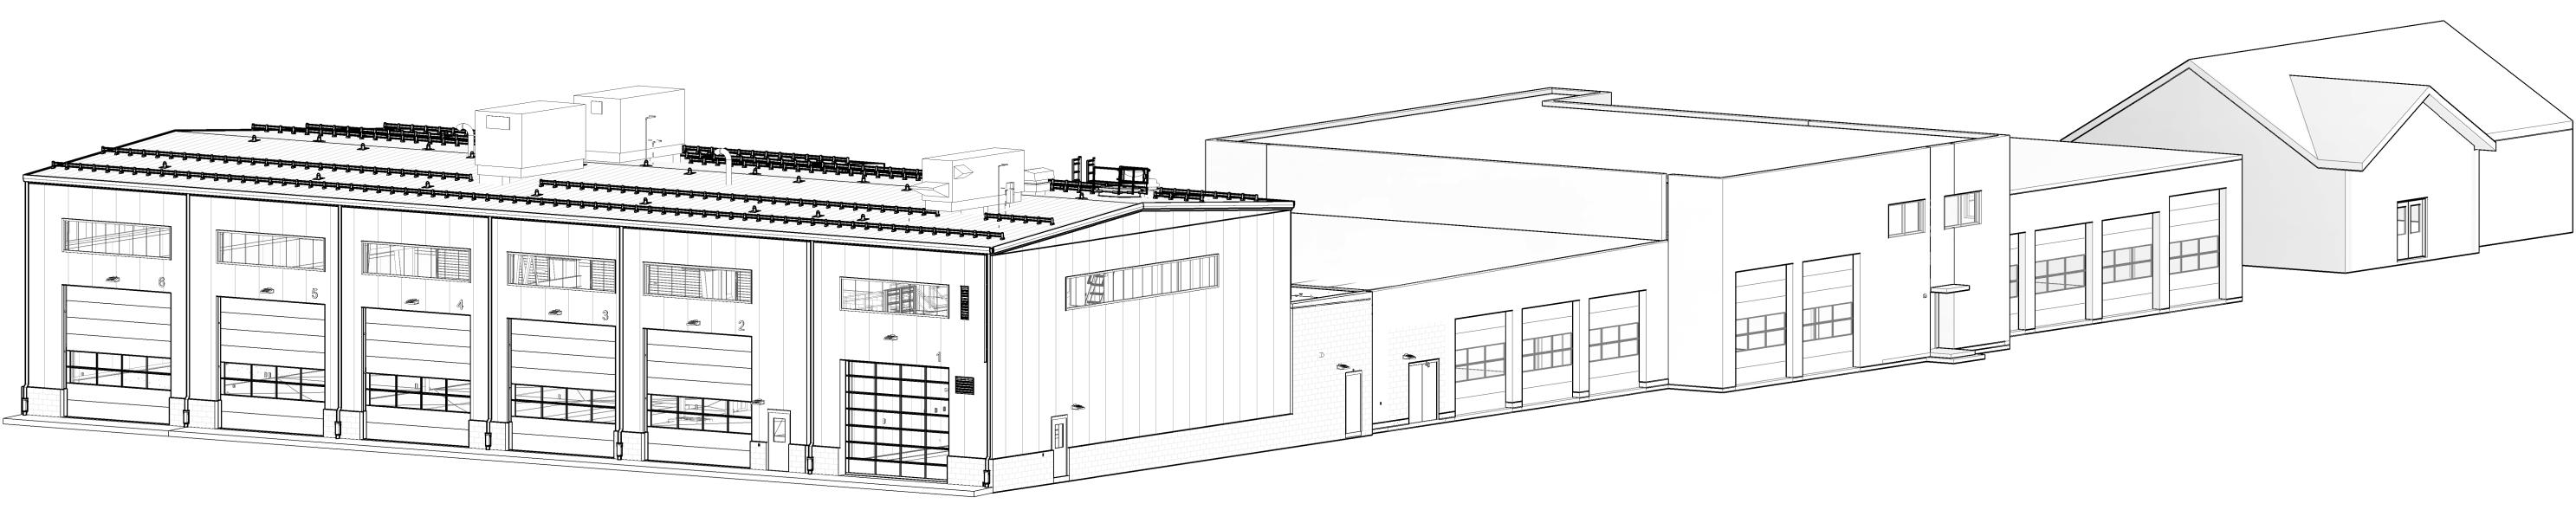


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